ROBBINS LIBRARY

EXTERIOR ENVELOPE REPAIRS - BID NO. 18-16



DRAWING SHEETS:

GENERAL G0-01 COVER SHEET

LANDSCAPE L1-01 EXISTING SITE PLAN

ARCHITECTURAL

A2-01 EAST EXTERIOR ELEVATION A2-02 SOUTH EXTERIOR ELEVATION

A2-03 WEST EXTERIOR ELEVATION

A2-04 NORTH EXTERIOR ELEVATION

A3-01 ENLARGED ELEVATION DETAILS

A3-02 ENLARGED ELEVATION DETAILS A4-01 STAIR REPAIR & RESTORATION DETAILS

A4-02 MASONRY REPAIR & RESTORATION DETAILS | G4

GENERAL NOTES:

- THE TOWN OF ARLINGTON AND CBI CONSULTING LLC. SHALL BE ADDED AS ADDITIONAL INSUREDS TO THE CONTRACTOR'S COMMERCIAL GENERAL LIABILITY AUTOMOBILE LIABILITY AND UMBRELLA POLICIES FOR THIS PROJECT. ALL OF THE CONTRACTOR'S INSURERS SHALL PROVIDE A WAIVER OF SUBROGATION IN FAVOR OF THE TOWN OF ARLINGTON AND CBI CONSULTING INC.
- ARCHITECT SHALL BE NOTIFIED AND SHALL RESOLVE THE CONFLICT. THE CONTRACTOR SHALL FIELD VERIFY ALL DIMENSIONS AND CONDITIONS.
- IN ANY CASE OF CONFLICT BETWEEN OR WITHIN THE DRAWINGS AND THE PROJECT SPECIFICATIONS OR WITHIN THE DRAWINGS OR SPECIFICATIONS, THE MORE STRINGENT REQUIREMENTS SHALL GOVERN AT THE SOLE DISCRETION OF
- THE CONTRACTOR SHALL MAKE NO DEVIATION FROM DESIGN DRAWINGS WITHOUT PRIOR REVIEW BY THE ARCHITECT
- WORK NOT INDICATED ON A PART OF THE DRAWINGS BUT REASONABLY IMPLIED TO BE SIMILAR TO THAT SHOWN AT CORRESPONDING PLACES SHALL BE REPEATED. ANY CONDITION FOUND NOT DETAILED SHALL BE CONSTRUCTED IN A MANNER SIMILAR TO THAT OF THE TYPICAL DETAILS.
- ALL WORK SHALL COMPLY WITH APPLICABLE CODES AND LOCAL LAWS AND REGULATIONS.
- GENERAL CONTRACTOR SHALL COORDINATE LOCATIONS OF OPENINGS, PITS, BOXES, SUMPS, TRENCHES, SLEEVES, DEPRESSIONS, GROOVES, AND CHAMFERS, WITH MECHANICAL, ELECTRICAL AND PLUMBING TRADES.
- THE STRUCTURAL DESIGN OF THE BUILDING IS BASED ON THE FULL INTERACTION OF ALL ITS COMPONENT PARTS. NO PROVISIONS HAVE BEEN MADE FOR CONDITIONS OCCURRING DURING CONSTRUCTION. IT IS THE SOLE RESPONSIBILITY OF THE CONTRACTOR TO MAKE PROPER AND ADEQUATE PROVISIONS FOR STABILITY OF, AND ALL STRESSES TO, THE STRUCTURE DUE TO ANY CAUSE DURING CONSTRUCTION.
- CONTRACTOR SHALL NOT SCALE DRAWINGS. CONTRACTOR SHALL REQUEST ALL DIMENSIONS OR INFORMATION REQUIRED TO PERFORM THE WORK FROM THE ARCHITECT. WORK COMPLETED BY THE CONTRACTOR WITHOUT DIMENSIONS OR INFORMATION SHALL BE DONE AT HIS OWN RISK AND SHALL BE REMOVED AND REINSTALLED TO THE SPECIFICATIONS OF THE ARCHITECT AT NO
- MEANS AND METHODS OF CONSTRUCTION AS WELL AS COMPLIANCE WITH OSHA AND OTHER SAFETY LAWS AND REGULATIONS IS EXCLUSIVE RESPONSIBILITY OF THE CONTRACTOR, HIS SUBCONTRACTOR(S), SUPPLIERS, CONSULTANTS AND
- - IF ANY DAMAGE OCCURS THE CONTRACTOR SHALL REPAIR THE ITEM SO IT IS IN A LIKE NEW CONDITION OR REPLACE IT WITH A NEW ITEM THAT
 - TO BE CAREFULLY REMOVED AND MOVED TO A PROTECTED AREA ON SITE OR TO AN OFF SITE FACILITY. THE ITEM IS TO BE CLEANED AND PREPARED TRANSPORT THE ITEM BACK TO ITS ORIGINAL LOCATION AND CAREFULLY REINSTALL. IF ANY DAMAGE OCCURS THE CONTRACTOR SHALL REPAIR THE ITEM SO IT IS IN A LIKE NEW CONDITION OR REPLACE IT WITH A NEW ITEM THAT FUNCTIONS THE SAME OR BETTER THAN THE ORIGINAL ITEM.

LIST OF ABBREVIATIONS ABOVE FINISH FLOOR

APPROX. APPROXIMATE

BIT.	BITUMINOUS	A I-
BUR	BUILT UP ROOFING	Arch
CB	CATCH BASIN	+
CMU	CONCRETE MASONRY UNIT	C
CONC.	CONCRETE	
CONT.	CONTINUOUS	
D.S.	DOWNSPOUT	
EQ	EQUAL	
E.W.	EACH WAY	
FD	FLOOR DRAIN	
HC	HANDICAP	
HT	HEIGHT	
IN	INVERT IN	
OUT	INVERT OUT	
D	INTERIOR DIAMETER	
L.C.C.	LEAD COATED COPPER	
MAX.	MAXIMUM	
MIN.	MINIMUM	
M.O.	MASONRY OPENING	
N/A	NOT APPLICABLE	
N.I.C.	NOT IN CONTRACT	
N.T.S.	NOT TO SCALE	2.5.6
O.C.	ON CENTER	250
OD	OVERHEAD DOOR	ВО
O.H.	OPPOSITE HAND	
PAV.	PAVERS	
P.T.	PRESSURE TREATED	D /
SIM.	SIMILAR TO	P: (
S.S.	STAINLESS STEEL	F: (
T.	TREAD	1. (
TYP.	TYPICAL	
U.O.N.	UNLESS OTHERWISE NOTED	
V/ I F	VEDIEV INTELLO	l chi

SYMBOL LEGEND SEE DETAIL 88 ON SHEET AX-XX

VERIFY IN FIELD

VINYL COVE BASE

ZINC COATED COPPER DIAMETER PLUS OR MINUS

U.O.N.

Z.C.C.

	BREAK LINE
*	DIMENSION LINE
•	EXTENT
00	DOOR TAG
(AA)	WINDOW TAG

CONTACT INFORMATION:

hitect



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ROBBINS LIBRARY TOWN OF **ARLINGTON**


700 MASSACHUSETTS AVENUE ARLINGTON MA, 02476

EXTERIOR ENVELOPE REPAIRS -BID NO. 18-16




COVER SHEET

BID **DOCUMENTS**

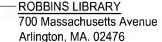


LOCATOR MAP

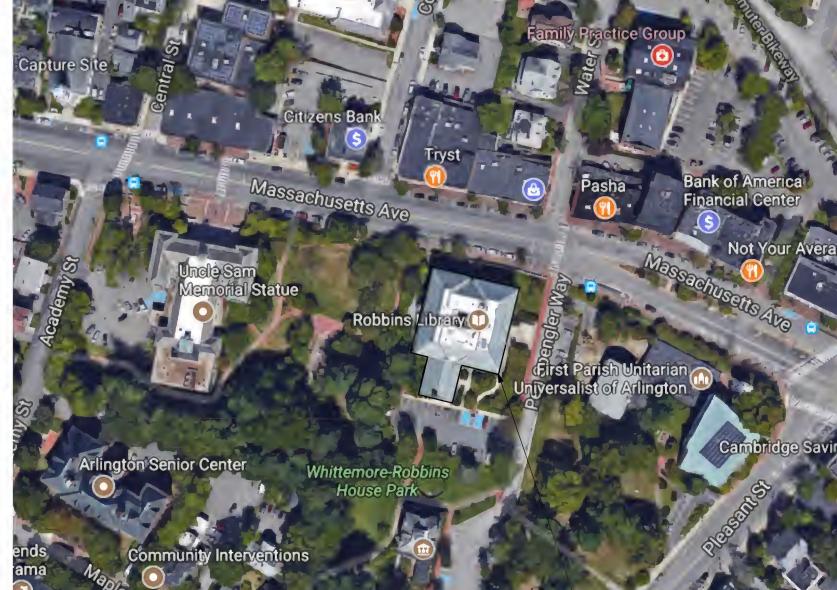

CONTRACTOR TO FIELD VERIFY ALL

DIMENSIONS AND CONDITIONS.

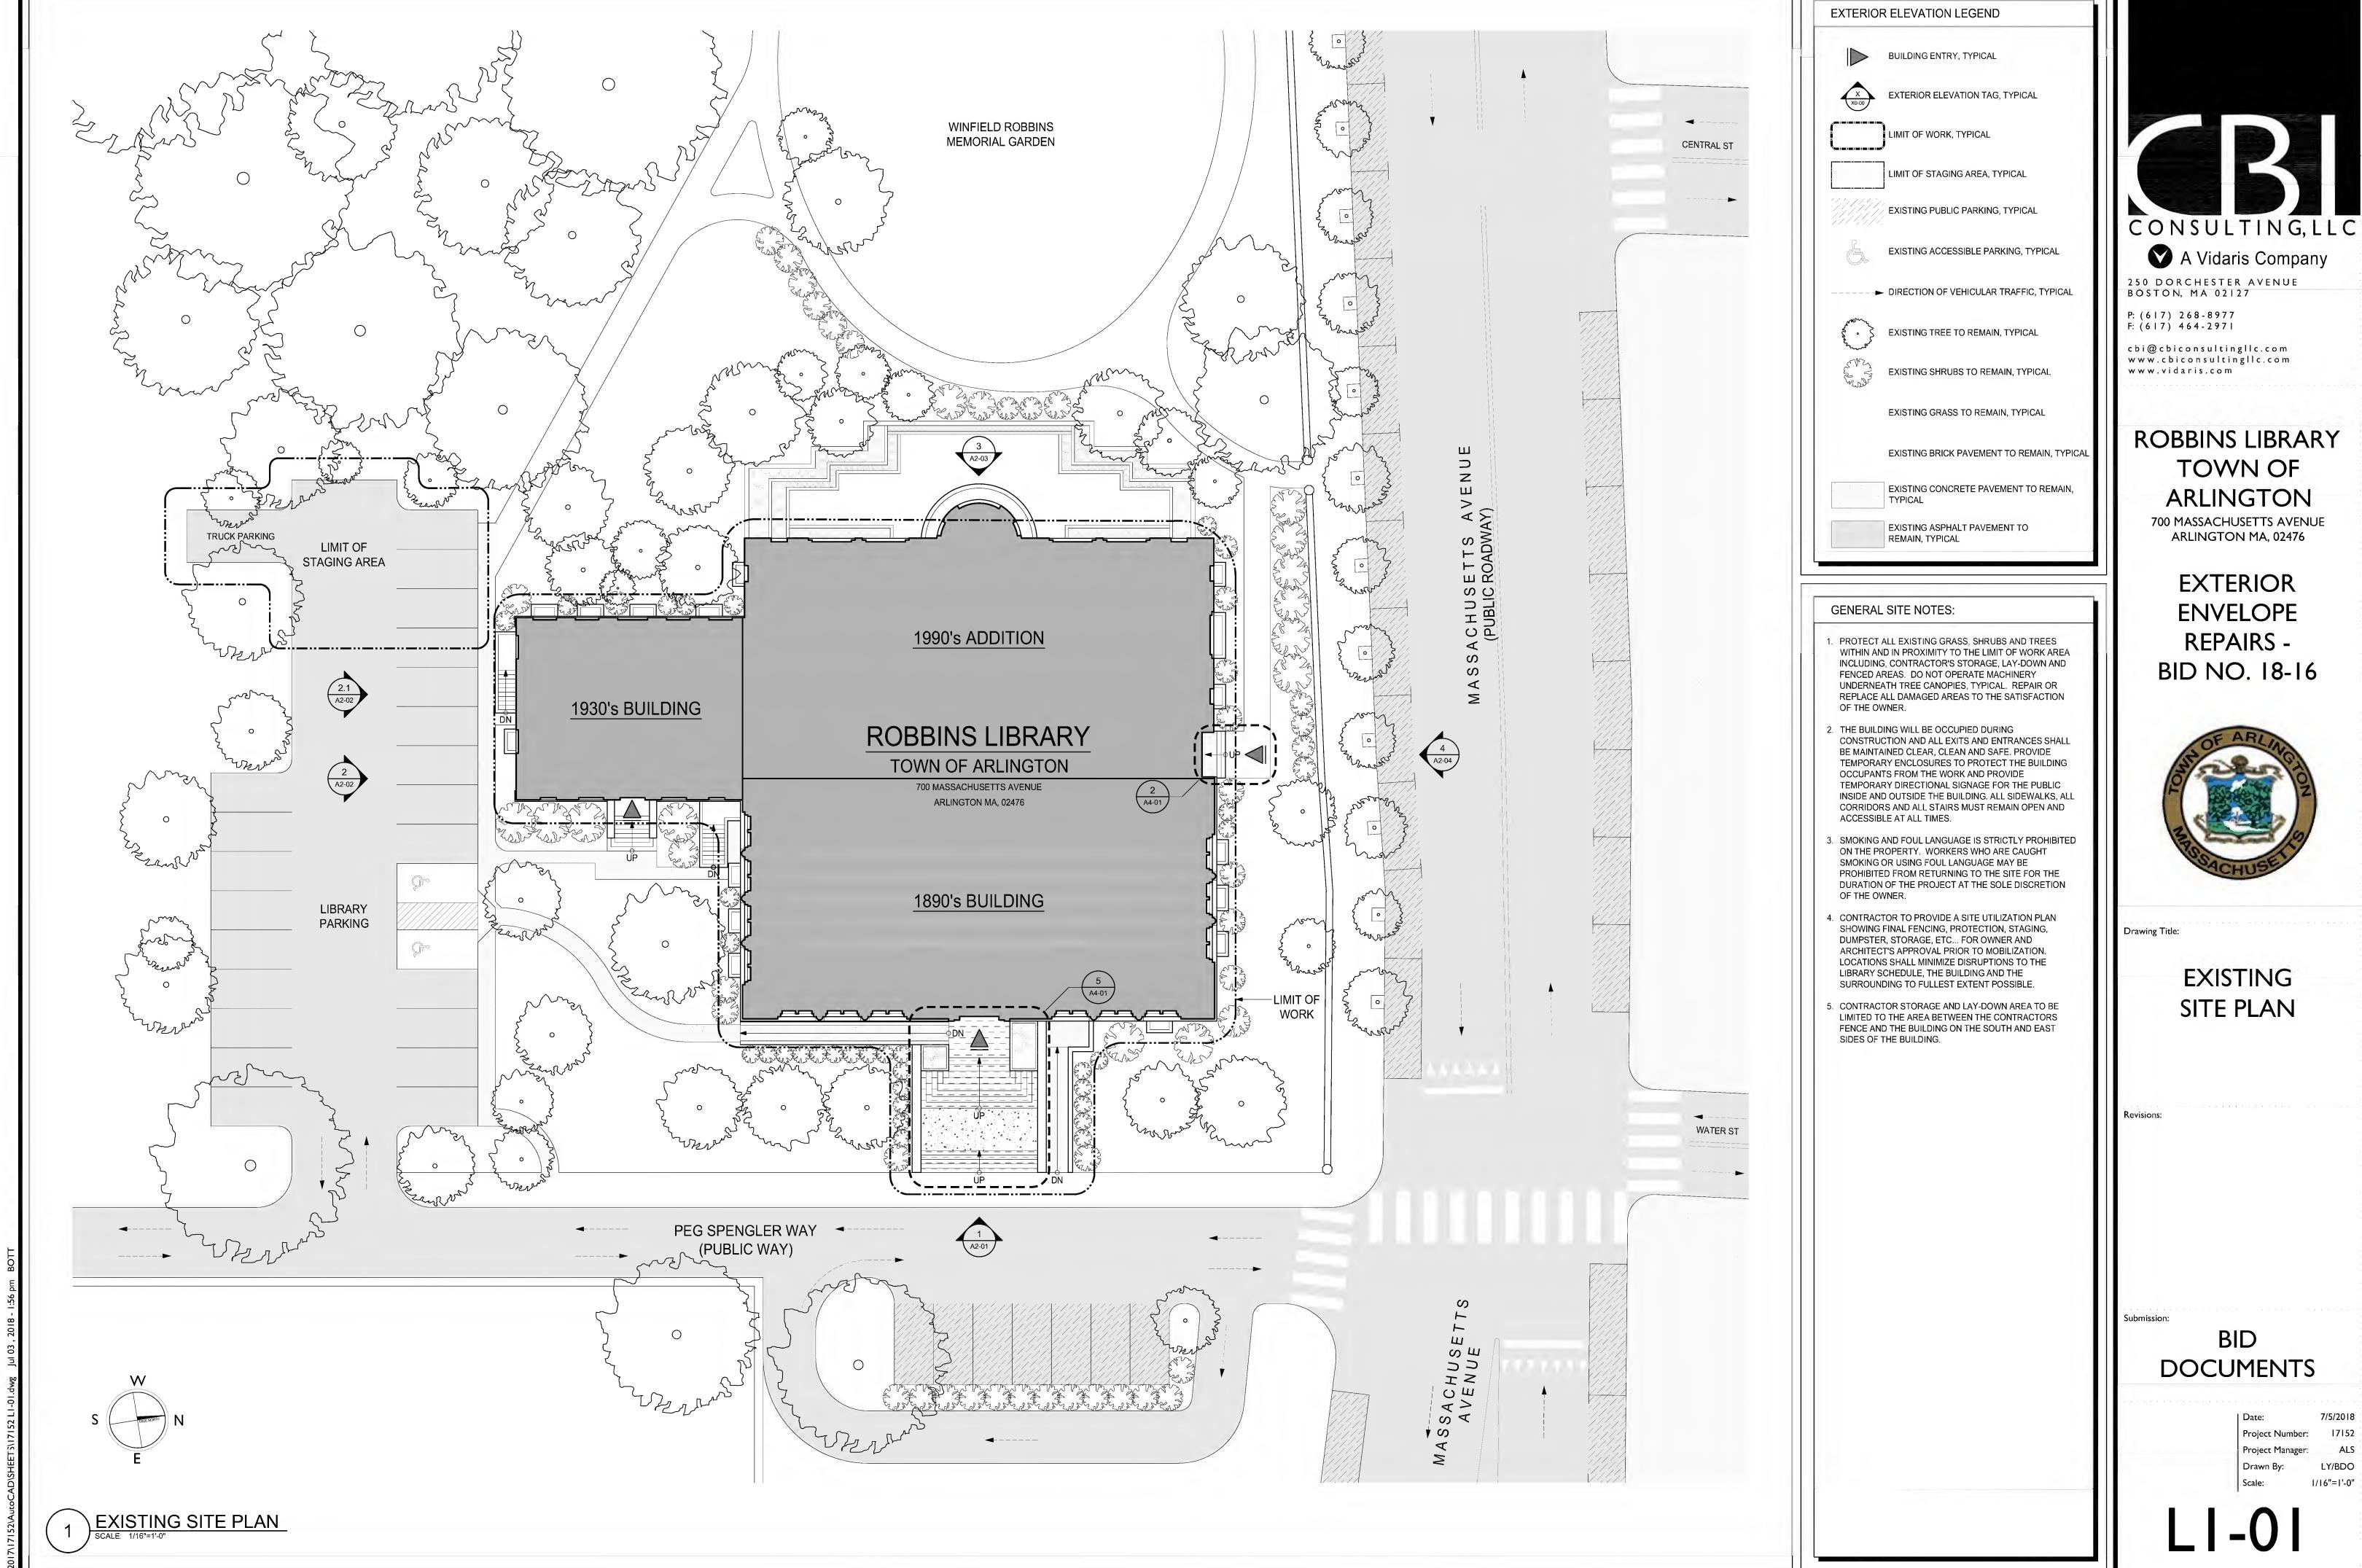

CONSULTING, LLC

SCALE: 1/8"=1'-0"

REPAIR AND RESTORATION WORK NOTES:

- 1. CUT AND POINT EXISTING SANDSTONE (1890'S BUILDING) FIELD STONE, WATER TABLE & ENTABLATURE MORTAR JOINTS INCLUDING HORIZONTIAL BED JOINTS AND VERTICAL HEAD JOINTS. APPLY NEW MORTAR WITH A BEADED "GRAPE VINE" PROFILE JOINT TO MATCH EXISTING. TOTAL QUANTITY OF <u>750 LINEAL FEET</u> IN SELECT AND RANDOM ACROSS ALL ELEVATIONS AS SELECTED BY ARCHITECT. REFER TO UNIT PRICES – SPECIFICATION 01 22 00.
- 2. CUT AND POINT EXISTING SANDSTONE (1890'S BUILDING) WINDOW TRIM, MOULDING, COLUMN PILASTERS AND COLUMN CAPITOL MORTAR JOINTS INCLUDING HORIZONTAL BED JOINTS AND VERTICAL RUNNING. APPLY NEW MORTAR WITH A BEADED PROFILE JOINT TO MATCH EXISTING. TOTAL QUANTITY OF <u>200 LINEAL FEET</u> IN SELECT AND RANDOM ACROSS ALL ELEVATIONS AS SELECTED BY ARCHITECT. REFER TO UNIT PRICES – SPECIFICATION 01 22 00.
- 3. CUT AND POINT EXISTING ORNATE SANDSTONE (1890'S BUILDING) CORNICE, SOFFIT, DENTILS, BRACKETS AND PEDIMENT MORTAR JOINT FEATURES INCLUDING HORIZONTÍAL BED JOINTS AND VERTICAL JOINTS. APPLY NEW MORTAR WITH A BEADED PROFILE JOINT TO MATCH EXISTING. TOTAL QUANTITY OF 375 LINEAL FEET IN SELECT AND RANDOM LOCATIONS ACROSS ALL ELEVATIONS AS SELECTED BY ARCHITECT. REFER TO UNIT PRICES – SPECIFICATION 01 22 00.
- 4. ROUTE AND CLEAN EXISTING CRACKS IN ANY SANDSTONE (1890'S BUILDING) DETAIL OR ELEMENT, AND FILL CRACKS WITH INJECTION RESTORATION REPAIR MORTAR. TOTAL QUANTITY OF 50 LINEAL FEET IN SELECT AND RANDOM LOCATIONS ACROSS ALL ELEVATIONS AS SELECTED BY ARCHITECT. REFER TO UNIT PRICES - SPECIFICATION 01 22 00 AND DEDUCT ALTERNATE NO. 4.
- 5. REPLACE GLASS AT EXISTING HALF ROUND ALUMINUM STORM WINDOWS FOR SIX (6) LOCATIONS ON THE 1890'S LIBRARY BUILDING. REMOVE EXISTING ALUMINUM STOP AND SALVAGE FOR REINSTALLATION. REMOVE AND DISPOSE OF EXISTING GLASS, AND INSTALL NEW 1/4-INCH CLEAR TEMPERED SAFETY GLASS. REINSTALL ALUMINUM SET IN A BED OF NON-SAG SINGLE COMPONENT, SILICONE SEALANT. REFER TO UNIT PRICES – SPECIFICATION 01 22 00
- 6. REPLACE EXISTING SEALANT AND MORTAR JOINTS OF THE EXTERIOR GRANITE STONE STAIRS, WITH INTERMEDIATE CONCRETE LANDING AT MAIN ENTRANCE OF THE 1890'S LIBRARY BUILDING. CUT, REMOVE AND DISPOSE OF 100% ALL EXISTING VERTICAL AND HORIZONTAL JOINT SEALANTS, INCLUDING UNDERLYING MORTAR A MINIMUM OF 1-1/2-INCHES OR UNTIL SOUND MORTAR FROM ALL GRANITE STONE STAIR AND CONCRETE LANDING JOINTS. APPLY NEW POINTING MORTAR TO WITHIN 1/2-INCH OF THE SURFACE AND APPLY POLYURETHANE SEALANT TO ALL GRANITE STONE JOINTS AND CONCRETE LANDING JOINTS. STAIRS SHALL BE POWER WASHED CLEANED. REFER TO DEDUCT ALTERNATE NO. 5.
- 7. CUT AND POINT EXISTING ARCHITECTURAL CAST STONE (1930'S BUILDING) FIELD STONE MORTAR JOINTS INCLUDING HORIZONTIAL BED JOINTS AND VERTICAL HEAD JOINTS. APPLY NEW MORTAR WITH A BEADED PROFILE JOINT TO MATCH EXISTING. TOTAL QUANTITY OF 180 LINEAL FEET IN SELECT AND RANDOM LOCATIONS ACROSS ALL ELEVATIONS AS SELECTED BY ARCHITECT. REFER TO UNIT PRICES - SPECIFICATION 01 22 00.

- 8. CUT AND POINT EXISTING ARCHITECTURAL CAST STONE (1930'S BUILDING) WINDOW TRIM, MOULDING, COLUMN PILASTERS AND COLUMN CAPITOL MORTAR JOINTS INCLUDING HORIZONTAL BED JOINTS AND VERTICAL RUNNING JOINTS. APPLY NEW MORTAR WITH A BEADED PROFILE JOINT TO MATCH EXISTING. TOTAL QUANTITY OF <u>100 LINEAL FEET</u> IN SELECT AND RANDOM LOCATIONS ACROSS ALL ELEVATIONS AS SELECTED BY ARCHITECT. REFER TO UNIT PRICES – SPECIFICATION 01 22 00.
- 9. CUT AND POINT EXISTING ORNATE ARCHITECTURAL CAST STONE (1930'S BUILDING) CORNICE AND SOFFIT MORTAR JOINT FEATURES INCLUDING HORIZONTAL BED JOINTS AND VERTICAL JOINTS. APPLY NEW MORTAR WITH A BEADED PROFILE JOINT TO MATCH EXISTING. TOTAL QUANTITY OF <u>120 LINEAL FEET</u> IN SELECT AND RANDOM LOCATIONS ACROSS ALL ELEVATIONS AS SELECTED BY ARCHITECT. REFER TO UNIT PRICES - SPECIFICATION 01 22 00.
- 10. ROUTE AND CLEAN EXISTING CRACKS IN ANY ARCHITECTURAL CAST STONE (1930'S BUILDING) DETAIL OR ELEMENT, AND FILL CRACKS WITH INJECTION RESTORATION REPAIR MORTAR. TOTAL QUANTITY OF 25 LINEAL FEET IN SELECT AND RANDOM LOCATIONS ACROSS ALL ELEVATIONS AS SELECTED BY ARCHITECT. REFER TO UNIT PRICES – SPECIFICATION 01 22 00 AND DEDUCT ALTERNATE NO. 2.
- 11. CUT AND POINT 100% OF ALL EXISTING BRICK MASONRY (1930'S BUILDING), INCLUDING ALL JOINTS BETWEEN THE BRICK AND THE ARCHITECTURAL CAST STONE SILLS, HEADS, QUOINS, AND CORNICE. CLEAN BRICK MASONRY IN ITS ENTIRETY AND APPLY CLEAR BREATHABLE MASONRY WATER REPELLENT
- 12. REMOVE AND DISPOSE OF THE EXISTING ARCHITECTURAL CAST STONE CORNICE SOFFIT AND FASCIA AND FABRICATE AND INSTALL. NEW ARCHITECTURAL CAST STONE TO MATCH TEXTURE AND COLOR. THE EXISTING COPPER GUTTER WILL NEED TO BE CAREFULLY REMOVED TO ACCESS CORNICE AND SHALL BE RE-INSTALLED. REFER TO DETAILS 3 THRU 12 ON SHEET A4-02.
- 13. REMOVE AND DISPOSE OF EXISTING ARCHITECTURAL CAST STONE WINDOW HEAD IN TWO (2) LOCATIONS AS SELECTED BY ARCHITECT. TEMPORARILY SHORE AND SUPPORT OPENING. FABRICATE AND INSTALL NEW REINFORCED ARCHITECTURAL PRECAST HEADER TO MATCH, SIZE, TEXTURE AND COLOR. REFER TO UNIT PRICES - SPECIFICATION 01 22 00 AND ADD DEDUCT ALTERNATE NO. 6.
- 14. RE-BUILD EXISTING EMERGENCY EXIT STAIRS ON THE MASS AVE SIDE OF THE LIBRARY BETWEEN THE 1890 AND 1990 BUILDINGS.
- REMOVE THE EXISTING GRANITE STAIR SIDE WALLS AND BRASS METAL HAND RAILS AND PAINTED METAL POSTS, STORE AND PROTECT FOR REINSTALLATION.
- RESTORE EXISTING HAND RAILS AND POSTS BY SCRAPING AND REMOVING EXISTING PAINT, AND THEN CLEAN, PREPARE, PRIME AND PAINT HANDRAIL AND POST SURFACES, EXCEPT FOR THE BRASS HANDRAIL SURFACE WHICH SHALL BE CLEANED ONLY.

- EXCAVATE, EXPOSE, REMOVE AND DISPOSE OF EXISTING CONCRETE STAIRS AND FOUNDATION IN ITS ENTIRETY, INCLUDING CONCRETE PAVERS ON TOP LANDING.
- FORM AND PLACE NEW REINFORCED CONCRETE FOOTINGS, WALLS AND STAIRS, AND RESET EXISTING GRANITE SIDEWALLS, ANCHORED AND PINNED TO NEW CONCRETE FOUNDATION.
- CAST RESTORED HANDRAILS AND POSTS INTO CONCRETE.

15. REPAIR CONCRETE STAIR, SOUTH ELEVATION OF 1930'S BUILDING.

- SELECTIVELY REMOVE & DISPOSE OF (1) 4FT X 4FT X 5-INCH CONCRETE SIDEWALK PANEL IN FRONT OF STAIR
- CUT, CHIP, AND REMOVE TOP LANDING OF STAIR, FLUSH WITH THE STAIR TREAD BELOW. SELECTIVELY CHIP AND REMOVE DETERIORATED CONCRETE FROM TOP OF THE STAIR WALL.
- SCRAPE AND REMOVE EXISTING PAINT FROM (2) PICKET FENCE RAIL POSTS BELOW THE BOTTOM
- FENCE RAIL, AND THEN CLEAN, PREPARE, PRIME AND PAINT SURFACES. REFER TO DEDUCT ALTERNATE NO. 3.

16. RE-SEAL EXISTING ALUMINUM SPANDREL PANELS AT 1990'S BUILDING.

- CUT, REMOVE & DISPOSE OF EXISTING RUBBER GASKETS FLUSH WITH PANEL FRAME. APPLY NEW BACKER ROD WHERE GASKETS ARE MISSING BETWEEN THE PANEL AND FRAME.
- CLEAN AND PRIME SURFACES AND APPLY NON-SAG SINGLE COMPONENT SILICONE SEALANT. COLOR TO BE SELECTED BY ARCHITECT FROM FULL RANGE OF CUSTOM COLORS.
- REFER TO DEDUCT ALTERNATE NO. 1.

DEDUCT ALTERNATES:

- 1. DEDUCT ALTERNATE NO.1 ELIMINATE ALL WORK ASSOCIATED TO RESEAL THE EXISTING ALUMINUM SPANDREL PANELS FOR THE 1990'S.
- 2. DEDUCT ALTERNATE NO.2 ELIMINATE ALL WORK ASSOCIATED WITH 25LF ARCHITECTURAL CAST STONE CRACK REPAIR FOR THE 1930'S BUILDING.
- DEDUCT ALTERNATE NO.3 ELIMINATE ALL WORK ASSOCIATED TO REPAIR STAIR AT 1930'S BUILDING.
- 4. DEDUCT ALTERNATE NO.4 ELIMINATE ALL WORK ASSOCIATED WITH 50LF OF SANDSTONE CRACK
- REPAIR FOR THE 1890'S BUILDING. 5. DEDUCT ALTERNATE NO.5 – ELIMINATE ALL WORK ASSOCIATED TO POWER WASH AND TO POINT EXTERIOR
- GRANITE STONE STAIRS AND TO RESEAL CONCRETE LANDING AT MAIN ENTRANCE OF THE 1890'S LIBRARY BUILDING. 6. DEDUCT ALTERNATE NO. 6 - ELIMINATE ALL WORK ASSOCIATED WITH REPLACING TWO (2) ARCHITECTURAL CAST STONE

REPAIR & RESTORATION WORK NOTE — LOCALIZED WORK LIMIT OF WORK

SLATE SHINGLES, TYPICAL BRICK MASONRY, TYPICAL

EXTERIOR ELEVATION LEGEND

METAL PANEL, TYPICAL WINDOW GLAZING, TYPICAL 1890's SANDSTONE MASONRY, TYPICAL

1930'S ARCHITECTURAL CAST STONE MASONRY, TYPICAL LIMESTONE PANEL TYPE I, TYPICAL

LIMESTONE PANEL TYPE II, TYPICAL



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ROBBINS LIBRARY TOWN OF ARLINGTON

700 MASSACHUSETTS AVENUE **ARLINGTON MA, 02476**

> **EXTERIOR ENVELOPE REPAIRS** -BID NO. 18-16



EAST EXTERIOR ELEVATIONS

DOCUMENTS

Project Manager: Drawn By:



2.1 PARTIAL SOUTH EXTERIOR ELEVATION SCALE: 1/8"=1'-0"

REPAIR AND RESTORATION WORK NOTES:

- 1. CUT AND POINT EXISTING SANDSTONE (1890'S BUILDING) FIELD STONE, WATER TABLE & ENTABLATURE MORTAR JOINTS INCLUDING HORIZONTIAL BED JOINTS AND VERTICAL HEAD JOINTS. APPLY NEW MORTAR WITH A BEADED "GRAPE VINE" PROFILE JOINT TO MATCH EXISTING. TOTAL QUANTITY OF 750 LINEAL FEET IN SELECT AND RANDOM ACROSS ALL ELEVATIONS AS SELECTED BY ARCHITECT. REFER TO UNIT PRICES SPECIFICATION 01 22 00.
- 2. CUT AND POINT EXISTING SANDSTONE (1890'S BUILDING) WINDOW TRIM, MOULDING, COLUMN PILASTERS AND COLUMN CAPITOL MORTAR JOINTS INCLUDING HORIZONTAL BED JOINTS AND VERTICAL RUNNING. APPLY NEW MORTAR WITH A BEADED PROFILE JOINT TO MATCH EXISTING. TOTAL QUANTITY OF 200 LINEAL FEET IN SELECT AND RANDOM ACROSS ALL ELEVATIONS AS SELECTED BY ARCHITECT. REFER TO UNIT PRICES SPECIFICATION 01 22 00.
- 3. CUT AND POINT EXISTING ORNATE SANDSTONE (1890'S BUILDING) CORNICE, SOFFIT, DENTILS, BRACKETS AND PEDIMENT MORTAR JOINT FEATURES INCLUDING HORIZONTIAL BED JOINTS AND VERTICAL JOINTS. APPLY NEW MORTAR WITH A BEADED PROFILE JOINT TO MATCH EXISTING. TOTAL QUANTITY OF 375 LINEAL FEET IN SELECT AND RANDOM LOCATIONS ACROSS ALL ELEVATIONS AS SELECTED BY ARCHITECT. REFER TO UNIT PRICES SPECIFICATION 01 22 00.
- 4. ROUTE AND CLEAN EXISTING CRACKS IN ANY SANDSTONE (1890'S BUILDING) DETAIL OR ELEMENT, AND FILL CRACKS WITH INJECTION RESTORATION REPAIR MORTAR. TOTAL QUANTITY OF 50 LINEAL FEET IN SELECT AND RANDOM LOCATIONS ACROSS ALL ELEVATIONS AS SELECTED BY ARCHITECT. REFER TO UNIT PRICES SPECIFICATION 01 22 00 AND DEDUCT ALTERNATE NO. 4.
- 5. REPLACE GLASS AT EXISTING HALF ROUND ALUMINUM STORM WINDOWS FOR SIX (6) LOCATIONS ON THE 1890'S LIBRARY BUILDING. REMOVE EXISTING ALUMINUM STOP AND SALVAGE FOR REINSTALLATION. REMOVE AND DISPOSE OF EXISTING GLASS, AND INSTALL NEW 1/4-INCH CLEAR TEMPERED SAFETY GLASS. REINSTALL ALUMINUM SET IN A BED OF NON-SAG SINGLE COMPONENT, SILICONE SEALANT. REFER TO UNIT PRICES SPECIFICATION 01 22 00
- 6. REPLACE EXISTING SEALANT AND MORTAR JOINTS OF THE EXTERIOR GRANITE STONE STAIRS, WITH INTERMEDIATE CONCRETE LANDING AT MAIN ENTRANCE OF THE 1890'S LIBRARY BUILDING. CUT, REMOVE AND DISPOSE OF 100% ALL EXISTING VERTICAL AND HORIZONTAL JOINT SEALANTS, INCLUDING UNDERLYING MORTAR A MINIMUM OF 1-1/2-INCHES OR UNTIL SOUND MORTAR FROM ALL GRANITE STONE STAIR AND CONCRETE LANDING JOINTS. APPLY NEW POINTING MORTAR TO WITHIN 1/2-INCH OF THE SURFACE AND APPLY POLYURETHANE SEALANT TO ALL GRANITE STONE JOINTS AND CONCRETE LANDING JOINTS. STAIRS SHALL BE POWER WASHED CLEANED. REFER TO DEDUCT ALTERNATE NO. 5.
- 7. CUT AND POINT EXISTING ARCHITECTURAL CAST STONE (1930'S BUILDING) FIELD STONE MORTAR JOINTS INCLUDING HORIZONTIAL BED JOINTS AND VERTICAL HEAD JOINTS. APPLY NEW MORTAR WITH A BEADED PROFILE JOINT TO MATCH EXISTING. TOTAL QUANTITY OF 180 LINEAL FEET IN SELECT AND RANDOM LOCATIONS ACROSS ALL ELEVATIONS AS SELECTED BY ARCHITECT. REFER TO UNIT PRICES SPECIFICATION 01 22 00.

- 8. CUT AND POINT EXISTING ARCHITECTURAL CAST STONE (1930'S BUILDING) WINDOW TRIM, MOULDING, COLUMN PILASTERS AND COLUMN CAPITOL MORTAR JOINTS INCLUDING HORIZONTAL BED JOINTS AND VERTICAL RUNNING JOINTS. APPLY NEW MORTAR WITH A BEADED PROFILE JOINT TO MATCH EXISTING. TOTAL QUANTITY OF 100 LINEAL FEET IN SELECT AND RANDOM LOCATIONS ACROSS ALL ELEVATIONS AS SELECTED BY ARCHITECT. REFER TO UNIT PRICES SPECIFICATION 01 22 00.
- 9. CUT AND POINT EXISTING ORNATE ARCHITECTURAL CAST STONE (1930'S BUILDING) CORNICE AND SOFFIT MORTAR JOINT FEATURES INCLUDING HORIZONTAL BED JOINTS AND VERTICAL JOINTS. APPLY NEW MORTAR WITH A BEADED PROFILE JOINT TO MATCH EXISTING. TOTAL QUANTITY OF 120 LINEAL FEET IN SELECT AND RANDOM LOCATIONS ACROSS ALL ELEVATIONS AS SELECTED BY ARCHITECT. REFER TO UNIT PRICES SPECIFICATION 01 22 00.
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- CUT AND POINT 100% OF ALL EXISTING BRICK MASONRY (1930'S BUILDING), INCLUDING ALL JOINTS BETWEEN THE BRICK AND THE ARCHITECTURAL CAST STONE SILLS, HEADS, QUOINS, AND CORNICE. CLEAN BRICK MASONRY IN ITS ENTIRETY AND APPLY CLEAR BREATHABLE MASONRY WATER REPELLENT
- 12. REMOVE AND DISPOSE OF THE EXISTING ARCHITECTURAL CAST STONE CORNICE SOFFIT AND FASCIA AND FABRICATE AND INSTALL. NEW ARCHITECTURAL CAST STONE TO MATCH TEXTURE AND COLOR. THE EXISTING COPPER GUTTER WILL NEED TO BE CAREFULLY REMOVED TO ACCESS CORNICE AND SHALL BE RE-INSTALLED. REFER TO DETAILS 3 THRU 12 ON SHEET A4-02.
- REMOVE AND DISPOSE OF EXISTING ARCHITECTURAL CAST STONE WINDOW HEAD IN TWO (2) LOCATIONS AS SELECTED BY ARCHITECT. TEMPORARILY SHORE AND SUPPORT OPENING. FABRICATE AND INSTALL NEW REINFORCED ARCHITECTURAL PRECAST HEADER TO MATCH, SIZE, TEXTURE AND COLOR. REFER TO UNIT PRICES SPECIFICATION 01 22 00 AND ADD DEDUCT ALTERNATE NO. 6.
- 14. RE-BUILD EXISTING EMERGENCY EXIT STAIRS ON THE MASS AVE SIDE OF THE LIBRARY BETWEEN THE 1890 AND 1990 BUILDINGS.
 - REMOVE THE EXISTING GRANITE STAIR SIDE WALLS AND BRASS METAL HAND RAILS AND PAINTED METAL POSTS, STORE AND PROTECT FOR REINSTALLATION.
 RESTORE EXISTING HAND RAILS AND POSTS BY SCRAPING AND REMOVING EXISTING PAINT, AND
 - THEN CLEAN, PREPARE, PRIME AND PAINT HANDRAIL AND POST SURFACES, EXCEPT FOR THE BRASS HANDRAIL SURFACE WHICH SHALL BE CLEANED ONLY.

- c. EXCAVATE, EXPOSE, REMOVE AND DISPOSE OF EXISTING CONCRETE STAIRS AND FOUNDATION IN ITS
- ENTIRETY, INCLUDING CONCRETE PAVERS ON TOP LANDING.
 d. FORM AND PLACE NEW REINFORCED CONCRETE FOOTINGS, WALLS AND STAIRS, AND RESET
- EXISTING GRANITE SIDEWALLS, ANCHORED AND PINNED TO NEW CONCRETE FOUNDATION.

 e. CAST RESTORED HANDRAILS AND POSTS INTO CONCRETE.

15. REPAIR CONCRETE STAIR, SOUTH ELEVATION OF 1930'S BUILDING.

- a. SELECTIVELY REMOVE & DISPOSE OF (1) 4FT X 4FT X 5-INCH CONCRETE SIDEWALK PANEL IN FRONT OF STAIR
- b. CUT, CHIP, AND REMOVE TOP LANDING OF STAIR, FLUSH WITH THE STAIR TREAD BELOW.
 c. SELECTIVELY CHIP AND REMOVE DETERIORATED CONCRETE FROM TOP OF THE STAIR WALL.
- d. SCRAPE AND REMOVE EXISTING PAINT FROM (2) PICKET FENCE RAIL POSTS BELOW THE BOTTOM
- FENCE RAIL, AND THEN CLEAN, PREPARE, PRIME AND PAINT SURFACES.
 e. REFER TO DEDUCT ALTERNATE NO. 3.

16. RE-SEAL EXISTING ALUMINUM SPANDREL PANELS AT 1990'S BUILDING.

- a. CUT, REMOVE & DISPOSE OF EXISTING RUBBER GASKETS FLUSH WITH PANEL FRAME.
 b. APPLY NEW BACKER ROD WHERE GASKETS ARE MISSING BETWEEN THE PANEL AND FRAME.
- CLEAN AND PRIME SURFACES AND APPLY NON-SAG SINGLE COMPONENT SILICONE SEALANT. COLOR TO BE SELECTED BY ARCHITECT FROM FULL RANGE OF CUSTOM COLORS.
- d. REFER TO DEDUCT ALTERNATE NO. 1.

DEDUCT ALTERNATES:

- 1. DEDUCT ALTERNATE NO.1 ELIMINATE ALL WORK ASSOCIATED TO RESEAL THE EXISTING ALUMINUM SPANDREL PANELS FOR THE 1990'S.
- 2. DEDUCT ALTERNATE NO.2 ELIMINATE ALL WORK ASSOCIATED WITH <u>25LF</u> ARCHITECTURAL CAST STONE CRACK REPAIR FOR THE 1930'S BUILDING.
- 3. DEDUCT ALTERNATE NO.3 ELIMINATE ALL WORK ASSOCIATED TO REPAIR STAIR AT 1930'S BUILDING.
- 4. DEDUCT ALTERNATE NO.4 ELIMINATE ALL WORK ASSOCIATED WITH 50LF OF SANDSTONE CRACK
- REPAIR FOR THE 1890'S BUILDING.
- 5. DEDUCT ALTERNATE NO.5 ELIMINATE ALL WORK ASSOCIATED TO POWER WASH AND TO POINT EXTERIOR GRANITE STONE STAIRS AND TO RESEAL CONCRETE LANDING AT MAIN ENTRANCE OF THE 1890'S LIBRARY BUILDING.
- 6. DEDUCT ALTERNATE NO. 6 ELIMINATE ALL WORK ASSOCIATED WITH REPLACING TWO (2) ARCHITECTURAL CAST STONE WINDOW HEADS.

REPAIR & RESTORATION WORK NOTE

LOCALIZED WORK

LIMIT OF WORK

SLATE SHINGLES, TYPICAL

BRICK MASONRY, TYPICAL

METAL PANEL, TYPICAL

WINDOW GLAZING, TYPICAL

1890's SANDSTONE MASONRY, TYPICAL

1930'S ARCHITECTURAL CAST STONE MASONRY, TYPICAL

LIMESTONE PANEL TYPE I, TYPICAL

LIMESTONE PANEL TYPE II, TYPICAL

EXTERIOR ELEVATION LEGEND

CONSULTING, LLC

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700 MASSACHUSETTS AVENUE ARLINGTON MA, 02476

EXTERIOR ENVELOPE REPAIRS -BID NO. 18-16



Drawing Title:

SOUTH EXTERIOR ELEVATIONS

Revisions

BID
DOCUMENTS

Project Number: 17152
Project Manager: ALS
Drawn By: LY/BDO
Scale: 1/8"=1'-0"

A2-02

REPAIR AND RESTORATION WORK NOTES:

- 1. CUT AND POINT EXISTING SANDSTONE (1890'S BUILDING) FIELD STONE, WATER TABLE & ENTABLATURE MORTAR JOINTS INCLUDING HORIZONTIAL BED JOINTS AND VERTICAL HEAD JOINTS. APPLY NEW MORTAR WITH A BEADED "GRAPE VINE" PROFILE JOINT TO MATCH EXISTING. TOTAL QUANTITY OF 750 LINEAL FEET IN SELECT AND RANDOM ACROSS ALL ELEVATIONS AS SELECTED BY ARCHITECT. REFER TO UNIT PRICES SPECIFICATION 01 22 00.
- 2. CUT AND POINT EXISTING SANDSTONE (1890'S BUILDING) WINDOW TRIM, MOULDING, COLUMN PILASTERS AND COLUMN CAPITOL MORTAR JOINTS INCLUDING HORIZONTAL BED JOINTS AND VERTICAL RUNNING. APPLY NEW MORTAR WITH A BEADED PROFILE JOINT TO MATCH EXISTING. TOTAL QUANTITY OF 200 LINEAL FEET IN SELECT AND RANDOM ACROSS ALL ELEVATIONS AS SELECTED BY ARCHITECT. REFER TO UNIT PRICES SPECIFICATION 01 22 00.
- 3. CUT AND POINT EXISTING ORNATE SANDSTONE (1890'S BUILDING) CORNICE, SOFFIT, DENTILS, BRACKETS AND PEDIMENT MORTAR JOINT FEATURES INCLUDING HORIZONTIAL BED JOINTS AND VERTICAL JOINTS. APPLY NEW MORTAR WITH A BEADED PROFILE JOINT TO MATCH EXISTING. TOTAL QUANTITY OF 375 LINEAL FEET IN SELECT AND RANDOM LOCATIONS ACROSS ALL ELEVATIONS AS SELECTED BY ARCHITECT. REFER TO UNIT PRICES SPECIFICATION 01 22 00.
- 4. ROUTE AND CLEAN EXISTING CRACKS IN ANY SANDSTONE (1890'S BUILDING) DETAIL OR ELEMENT, AND FILL CRACKS WITH INJECTION RESTORATION REPAIR MORTAR. TOTAL QUANTITY OF 50 LINEAL FEET IN SELECT AND RANDOM LOCATIONS ACROSS ALL ELEVATIONS AS SELECTED BY ARCHITECT. REFER TO UNIT PRICES SPECIFICATION 01 22 00 AND DEDUCT ALTERNATE NO. 4.
- 5. REPLACE GLASS AT EXISTING HALF ROUND ALUMINUM STORM WINDOWS FOR SIX (6) LOCATIONS ON THE 1890'S LIBRARY BUILDING. REMOVE EXISTING ALUMINUM STOP AND SALVAGE FOR REINSTALLATION. REMOVE AND DISPOSE OF EXISTING GLASS, AND INSTALL NEW 1/4-INCH CLEAR TEMPERED SAFETY GLASS. REINSTALL ALUMINUM SET IN A BED OF NON-SAG SINGLE COMPONENT, SILICONE SEALANT. REFER TO UNIT PRICES SPECIFICATION 01 22 00
- 6. REPLACE EXISTING SEALANT AND MORTAR JOINTS OF THE EXTERIOR GRANITE STONE STAIRS, WITH INTERMEDIATE CONCRETE LANDING AT MAIN ENTRANCE OF THE 1890'S LIBRARY BUILDING. CUT, REMOVE AND DISPOSE OF 100% ALL EXISTING VERTICAL AND HORIZONTAL JOINT SEALANTS, INCLUDING UNDERLYING MORTAR A MINIMUM OF 1-1/2-INCHES OR UNTIL SOUND MORTAR FROM ALL GRANITE STONE STAIR AND CONCRETE LANDING JOINTS. APPLY NEW POINTING MORTAR TO WITHIN 1/2-INCH OF THE SURFACE AND APPLY POLYURETHANE SEALANT TO ALL GRANITE STONE JOINTS AND CONCRETE LANDING JOINTS. STAIRS SHALL BE POWER WASHED CLEANED. REFER TO DEDUCT ALTERNATE NO. 5.
- 7. CUT AND POINT EXISTING ARCHITECTURAL CAST STONE (1930'S BUILDING) FIELD STONE MORTAR JOINTS INCLUDING HORIZONTIAL BED JOINTS AND VERTICAL HEAD JOINTS. APPLY NEW MORTAR WITH A BEADED PROFILE JOINT TO MATCH EXISTING. TOTAL QUANTITY OF 180 LINEAL FEET IN SELECT AND RANDOM LOCATIONS ACROSS ALL ELEVATIONS AS SELECTED BY ARCHITECT. REFER TO UNIT PRICES SPECIFICATION 01 22 00.

- 8. CUT AND POINT EXISTING ARCHITECTURAL CAST STONE (1930'S BUILDING) WINDOW TRIM, MOULDING, COLUMN PILASTERS AND COLUMN CAPITOL MORTAR JOINTS INCLUDING HORIZONTAL BED JOINTS AND VERTICAL RUNNING JOINTS. APPLY NEW MORTAR WITH A BEADED PROFILE JOINT TO MATCH EXISTING. TOTAL QUANTITY OF 100 LINEAL FEET IN SELECT AND RANDOM LOCATIONS ACROSS ALL ELEVATIONS AS SELECTED BY ARCHITECT. REFER TO UNIT PRICES SPECIFICATION 01 22 00.
- 9. CUT AND POINT EXISTING ORNATE ARCHITECTURAL CAST STONE (1930'S BUILDING) CORNICE AND SOFFIT MORTAR JOINT FEATURES INCLUDING HORIZONTAL BED JOINTS AND VERTICAL JOINTS. APPLY NEW MORTAR WITH A BEADED PROFILE JOINT TO MATCH EXISTING. TOTAL QUANTITY OF 120 LINEAL FEET IN SELECT AND RANDOM LOCATIONS ACROSS ALL ELEVATIONS AS SELECTED BY ARCHITECT. REFER TO UNIT PRICES SPECIFICATION 01 22 00.
- 10. ROUTE AND CLEAN EXISTING CRACKS IN ANY ARCHITECTURAL CAST STONE (1930'S BUILDING) DETAIL OR ELEMENT, AND FILL CRACKS WITH INJECTION RESTORATION REPAIR MORTAR. TOTAL QUANTITY OF 25 LINEAL FEET IN SELECT AND RANDOM LOCATIONS ACROSS ALL ELEVATIONS AS SELECTED BY ARCHITECT. REFER TO UNIT PRICES SPECIFICATION 01 22 00 AND DEDUCT ALTERNATE NO. 2.
- 11. CUT AND POINT 100% OF ALL EXISTING BRICK MASONRY (1930'S BUILDING), INCLUDING ALL JOINTS BETWEEN THE BRICK AND THE ARCHITECTURAL CAST STONE SILLS, HEADS, QUOINS, AND CORNICE. CLEAN BRICK MASONRY IN ITS ENTIRETY AND APPLY CLEAR BREATHABLE MASONRY WATER REPELLENT.
- 12. REMOVE AND DISPOSE OF THE EXISTING ARCHITECTURAL CAST STONE CORNICE SOFFIT AND FASCIA AND FABRICATE AND INSTALL. NEW ARCHITECTURAL CAST STONE TO MATCH TEXTURE AND COLOR. THE EXISTING COPPER GUTTER WILL NEED TO BE CAREFULLY REMOVED TO ACCESS CORNICE AND SHALL BE RE-INSTALLED. REFER TO DETAILS 3 THRU 12 ON SHEET A4-02.
- REMOVE AND DISPOSE OF EXISTING ARCHITECTURAL CAST STONE WINDOW HEAD IN TWO (2) LOCATIONS AS SELECTED BY ARCHITECT. TEMPORARILY SHORE AND SUPPORT OPENING. FABRICATE AND INSTALL NEW REINFORCED ARCHITECTURAL PRECAST HEADER TO MATCH, SIZE, TEXTURE AND COLOR. REFER TO UNIT PRICES SPECIFICATION 01 22 00 AND ADD DEDUCT ALTERNATE NO. 6.
- 14. RE-BUILD EXISTING EMERGENCY EXIT STAIRS ON THE MASS AVE SIDE OF THE LIBRARY BETWEEN THE 1890 AND 1990 BUILDINGS.
 - METAL POSTS, STORE AND PROTECT FOR REINSTALLATION.
 b. RESTORE EXISTING HAND RAILS AND POSTS BY SCRAPING AND REMOVING EXISTING PAINT, AND THEN CLEAN, PREPARE, PRIME AND PAINT HANDRAIL AND POST SURFACES, EXCEPT FOR THE BRASS HANDRAIL SURFACE WHICH SHALL BE CLEANED ONLY.

REMOVE THE EXISTING GRANITE STAIR SIDE WALLS AND BRASS METAL HAND RAILS AND PAINTED

- c. EXCAVATE, EXPOSE, REMOVE AND DISPOSE OF EXISTING CONCRETE STAIRS AND FOUNDATION IN ITS ENTIRETY, INCLUDING CONCRETE PAVERS ON TOP LANDING.
- FORM AND PLACE NEW REINFORCED CONCRETE FOOTINGS, WALLS AND STAIRS, AND RESET EXISTING GRANITE SIDEWALLS, ANCHORED AND PINNED TO NEW CONCRETE FOUNDATION. CAST RESTORED HANDRAILS AND POSTS INTO CONCRETE.
- REPAIR CONCRETE STAIR, SOUTH ELEVATION OF 1930'S BUILDING.
 a. SELECTIVELY REMOVE & DISPOSE OF (1) 4FT X 4FT X 5-INCH CONCRETE SIDEWALK PANEL IN FRONT OF STAIR
 b. CUT, CHIP, AND REMOVE TOP LANDING OF STAIR, FLUSH WITH THE STAIR TREAD BELOW.
- c. SELECTIVELY CHIP AND REMOVE DETERIORATED CONCRETE FROM TOP OF THE STAIR WALL.
 d. SCRAPE AND REMOVE EXISTING PAINT FROM (2) PICKET FENCE RAIL POSTS BELOW THE BOTTOM FENCE RAIL, AND THEN CLEAN, PREPARE, PRIME AND PAINT SURFACES.
 e. REFER TO DEDUCT ALTERNATE NO. 3.
- 16. RE-SEAL EXISTING ALUMINUM SPANDREL PANELS AT 1990'S BUILDING.
- a. CUT, REMOVE & DISPOSE OF EXISTING RUBBER GASKETS FLUSH WITH PANEL FRAME.
- b. APPLY NEW BACKER ROD WHERE GASKETS ARE MISSING BETWEEN THE PANEL AND FRAME.
 c. CLEAN AND PRIME SURFACES AND APPLY NON-SAG SINGLE COMPONENT SILICONE SEALANT.
 COLOR TO BE SELECTED BY ARCHITECT FROM FULL RANGE OF CUSTOM COLORS.
- d. REFER TO DEDUCT ALTERNATE NO. 1.
- 1. DEDUCT ALTERNATE NO.1 ELIMINATE ALL WORK ASSOCIATED TO RESEAL THE EXISTING ALUMINUM SPANDREL PANELS FOR THE 1990'S.
- 2. DEDUCT ALTERNATE NO.2 ELIMINATE ALL WORK ASSOCIATED WITH <u>25LF</u> ARCHITECTURAL CAST STONE CRACK REPAIR FOR THE 1930'S BUILDING.
- 3. DEDUCT ALTERNATE NO.3 ELIMINATE ALL WORK ASSOCIATED TO REPAIR STAIR AT 1930'S BUILDING.
- deduct alternate No.4 Eliminate all work associated with <u>50LF</u> of Sandstone crack repair for the 1890's Building.
- 5. DEDUCT ALTERNATE NO.5 ELIMINATE ALL WORK ASSOCIATED TO POWER WASH AND TO POINT EXTERIOR GRANITE STONE STAIRS AND TO RESEAL CONCRETE LANDING AT MAIN ENTRANCE OF THE 1890'S LIBRARY BUILDING.
- 6. DEDUCT ALTERNATE NO. 6 ELIMINATE ALL WORK ASSOCIATED WITH REPLACING TWO (2) ARCHITECTURAL CAST STONE WINDOW HEADS.

REPAIR & RESTORATION WORK NOTE

LOCALIZED WORK

LIMIT OF WORK

SLATE SHINGLES, TYPICAL

BRICK MASONRY, TYPICAL

METAL PANEL, TYPICAL

WINDOW GLAZING, TYPICAL

1890'S SANDSTONE MASONRY, TYPICAL

1930'S ARCHITECTURAL CAST STONE
MASONRY, TYPICAL

LIMESTONE PANEL TYPE I, TYPICAL

LIMESTONE PANEL TYPE II, TYPICAL

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EXTERIOR ENVELOPE REPAIRS -BID NO. 18-16



Drawing Title:

WEST EXTERIOR ELEVATIONS

Revisions:

BID DOCUMENTS

Project Number:
Project Manager:
Drawn By:

1/8"=1'-0"

A2-03



REPAIR AND RESTORATION WORK NOTES:

- 1. CUT AND POINT EXISTING SANDSTONE (1890'S BUILDING) FIELD STONE, WATER TABLE & ENTABLATURE MORTAR JOINTS INCLUDING HORIZONTIAL BED JOINTS AND VERTICAL HEAD JOINTS. APPLY NEW MORTAR WITH A BEADED "GRAPE VINE" PROFILE JOINT TO MATCH EXISTING. TOTAL QUANTITY OF 750 LINEAL FEET IN SELECT AND RANDOM ACROSS ALL ELEVATIONS AS SELECTED BY ARCHITECT. REFER TO UNIT PRICES SPECIFICATION 01 22 00.
- 2. CUT AND POINT EXISTING SANDSTONE (1890'S BUILDING) WINDOW TRIM, MOULDING, COLUMN PILASTERS AND COLUMN CAPITOL MORTAR JOINTS INCLUDING HORIZONTAL BED JOINTS AND VERTICAL RUNNING. APPLY NEW MORTAR WITH A BEADED PROFILE JOINT TO MATCH EXISTING. TOTAL QUANTITY OF 200 LINEAL FEET IN SELECT AND RANDOM ACROSS ALL ELEVATIONS AS SELECTED BY ARCHITECT. REFER TO UNIT PRICES SPECIFICATION 01 22 00.
- 3. CUT AND POINT EXISTING ORNATE SANDSTONE (1890'S BUILDING) CORNICE, SOFFIT, DENTILS, BRACKETS AND PEDIMENT MORTAR JOINT FEATURES INCLUDING HORIZONTIAL BED JOINTS AND VERTICAL JOINTS. APPLY NEW MORTAR WITH A BEADED PROFILE JOINT TO MATCH EXISTING. TOTAL QUANTITY OF 375 LINEAL FEET IN SELECT AND RANDOM LOCATIONS ACROSS ALL ELEVATIONS AS SELECTED BY ARCHITECT. REFER TO UNIT PRICES SPECIFICATION 01 22 00.
- 4. ROUTE AND CLEAN EXISTING CRACKS IN ANY SANDSTONE (1890'S BUILDING) DETAIL OR ELEMENT, AND FILL CRACKS WITH INJECTION RESTORATION REPAIR MORTAR. TOTAL QUANTITY OF 50 LINEAL FEET IN SELECT AND RANDOM LOCATIONS ACROSS ALL ELEVATIONS AS SELECTED BY ARCHITECT. REFER TO UNIT PRICES SPECIFICATION 01 22 00 AND DEDUCT ALTERNATE NO. 4.
- 5. REPLACE GLASS AT EXISTING HALF ROUND ALUMINUM STORM WINDOWS FOR SIX (6) LOCATIONS ON THE 1890'S LIBRARY BUILDING. REMOVE EXISTING ALUMINUM STOP AND SALVAGE FOR REINSTALLATION. REMOVE AND DISPOSE OF EXISTING GLASS, AND INSTALL NEW 1/4-INCH CLEAR TEMPERED SAFETY GLASS. REINSTALL ALUMINUM SET IN A BED OF NON-SAG SINGLE
- COMPONENT, SILICONE SEALANT. REFER TO UNIT PRICES SPECIFICATION 01 22 00

 REPLACE EXISTING SEALANT AND MORTAR JOINTS OF THE EXTERIOR GRANITE STONE STAIRS, WITH INTERMEDIATE CONCRETE LANDING AT MAIN ENTRANCE OF THE 1890'S LIBRARY BUILDING. CUT, REMOVE AND DISPOSE OF 100% ALL EXISTING VERTICAL AND HORIZONTAL JOINT SEALANTS, INCLUDING UNDERLYING MORTAR A MINIMUM OF 1-1/2-INCHES OR UNTIL SOUND MORTAR FROM ALL GRANITE STONE STAIR AND CONCRETE LANDING JOINTS. APPLY NEW POINTING MORTAR TO WITHIN 1/2-INCH OF THE SURFACE AND APPLY POLYURETHANE SEALANT TO ALL GRANITE STONE JOINTS AND CONCRETE LANDING JOINTS. STAIRS SHALL BE POWER WASHED CLEANED. REFER TO DEDUCT ALTERNATE NO. 5.
- 7. CUT AND POINT EXISTING ARCHITECTURAL CAST STONE (1930'S BUILDING) FIELD STONE MORTAR JOINTS INCLUDING HORIZONTIAL BED JOINTS AND VERTICAL HEAD JOINTS. APPLY NEW MORTAR WITH A BEADED PROFILE JOINT TO MATCH EXISTING. TOTAL QUANTITY OF 180 LINEAL FEET IN SELECT AND RANDOM LOCATIONS ACROSS ALL ELEVATIONS AS SELECTED BY ARCHITECT. REFER TO UNIT PRICES SPECIFICATION 01 22 00.

- 8. CUT AND POINT EXISTING ARCHITECTURAL CAST STONE (1930'S BUILDING) WINDOW TRIM, MOULDING, COLUMN PILASTERS AND COLUMN CAPITOL MORTAR JOINTS INCLUDING HORIZONTAL BED JOINTS AND VERTICAL RUNNING JOINTS. APPLY NEW MORTAR WITH A BEADED PROFILE JOINT TO MATCH EXISTING. TOTAL QUANTITY OF 100 LINEAL FEET IN SELECT AND RANDOM LOCATIONS ACROSS ALL ELEVATIONS AS SELECTED BY ARCHITECT. REFER TO UNIT PRICES SPECIFICATION 01 22 00.
- 9. CUT AND POINT EXISTING ORNATE ARCHITECTURAL CAST STONE (1930'S BUILDING) CORNICE AND SOFFIT MORTAR JOINT FEATURES INCLUDING HORIZONTAL BED JOINTS AND VERTICAL JOINTS. APPLY NEW MORTAR WITH A BEADED PROFILE JOINT TO MATCH EXISTING. TOTAL QUANTITY OF 120 LINEAL FEET IN SELECT AND RANDOM LOCATIONS ACROSS ALL ELEVATIONS AS SELECTED BY ARCHITECT. REFER TO UNIT PRICES SPECIFICATION 01 22 00.
- 10. ROUTE AND CLEAN EXISTING CRACKS IN ANY ARCHITECTURAL CAST STONE (1930'S BUILDING) DETAIL OR ELEMENT, AND FILL CRACKS WITH INJECTION RESTORATION REPAIR MORTAR. TOTAL QUANTITY OF 25 LINEAL FEET IN SELECT AND RANDOM LOCATIONS ACROSS ALL ELEVATIONS AS SELECTED BY ARCHITECT. REFER TO UNIT PRICES SPECIFICATION 01 22 00 AND DEDUCT ALTERNATE NO. 2.
- 11. CUT AND POINT 100% OF ALL EXISTING BRICK MASONRY (1930'S BUILDING), INCLUDING ALL JOINTS BETWEEN THE BRICK AND THE ARCHITECTURAL CAST STONE SILLS, HEADS, QUOINS, AND CORNICE. CLEAN BRICK MASONRY IN ITS ENTIRETY AND APPLY CLEAR BREATHABLE MASONRY WATER REPELLENT.
- 12. REMOVE AND DISPOSE OF THE EXISTING ARCHITECTURAL CAST STONE CORNICE SOFFIT AND FASCIA AND FABRICATE AND INSTALL. NEW ARCHITECTURAL CAST STONE TO MATCH TEXTURE AND COLOR. THE EXISTING COPPER GUTTER WILL NEED TO BE CAREFULLY REMOVED TO ACCESS CORNICE AND SHALL BE RE-INSTALLED. REFER TO DETAILS 3 THRU 12 ON SHEET A4-02.
- 13. REMOVE AND DISPOSE OF EXISTING ARCHITECTURAL CAST STONE WINDOW HEAD IN TWO (2) LOCATIONS AS SELECTED BY ARCHITECT. TEMPORARILY SHORE AND SUPPORT OPENING. FABRICATE AND INSTALL NEW REINFORCED ARCHITECTURAL PRECAST HEADER TO MATCH, SIZE, TEXTURE AND COLOR. REFER TO UNIT PRICES SPECIFICATION 01 22 00 AND ADD DEDUCT ALTERNATE NO. 6.
- RE-BUILD EXISTING EMERGENCY EXIT STAIRS ON THE MASS AVE SIDE OF THE LIBRARY BETWEEN THE 1890 AND 1990 BUILDINGS.
 - REMOVE THE EXISTING GRANITE STAIR SIDE WALLS AND BRASS METAL HAND RAILS AND PAINTED METAL POSTS, STORE AND PROTECT FOR REINSTALLATION.
 RESTORE EXISTING HAND RAILS AND POSTS BY SCRAPING AND REMOVING EXISTING PAINT, AND
 - THEN CLEAN, PREPARE, PRIME AND PAINT HANDRAIL AND POST SURFACES, EXCEPT FOR THE BRASS HANDRAIL SURFACE WHICH SHALL BE CLEANED ONLY.

- c. EXCAVATE, EXPOSE, REMOVE AND DISPOSE OF EXISTING CONCRETE STAIRS AND FOUNDATION IN ITS ENTIRETY, INCLUDING CONCRETE PAVERS ON TOP LANDING.
- d. FORM AND PLACE NEW REINFORCED CONCRETE FOOTINGS, WALLS AND STAIRS, AND RESET EXISTING GRANITE SIDEWALLS, ANCHORED AND PINNED TO NEW CONCRETE FOUNDATION.
 e. CAST RESTORED HANDRAILS AND POSTS INTO CONCRETE.
- 15. REPAIR CONCRETE STAIR, SOUTH ELEVATION OF 1930'S BUILDING.
- a. SELECTIVELY REMOVE & DISPOSE OF (1) 4FT X 4FT X 5-INCH CONCRETE SIDEWALK PANEL IN FRONT OF STAIR b. CUT, CHIP, AND REMOVE TOP LANDING OF STAIR, FLUSH WITH THE STAIR TREAD BELOW.
- c. SELECTIVELY CHIP AND REMOVE DETERIORATED CONCRETE FROM TOP OF THE STAIR WALL.
 d. SCRAPE AND REMOVE EXISTING PAINT FROM (2) PICKET FENCE RAIL POSTS BELOW THE BOTTOM
- FENCE RAIL, AND THEN CLEAN, PREPARE, PRIME AND PAINT SURFACES.
- e. REFER TO DEDUCT ALTERNATE NO. 3.
- 16. RE-SEAL EXISTING ALUMINUM SPANDREL PANELS AT 1990'S BUILDING.
- a. CUT, REMOVE & DISPOSE OF EXISTING RUBBER GASKETS FLUSH WITH PANEL FRAME.
 b. APPLY NEW BACKER ROD WHERE GASKETS ARE MISSING BETWEEN THE PANEL AND FRAME.
- c. CLEAN AND PRIME SURFACES AND APPLY NON-SAG SINGLE COMPONENT SILICONE SEALANT. COLOR TO BE SELECTED BY ARCHITECT FROM FULL RANGE OF CUSTOM COLORS.
- d. REFER TO DEDUCT ALTERNATE NO. 1.

DEDUCT ALTERNATES:

- 1. DEDUCT ALTERNATE NO.1 ELIMINATE ALL WORK ASSOCIATED TO RESEAL THE EXISTING ALUMINUM SPANDREL PANELS FOR THE 1990'S.
- 2. DEDUCT ALTERNATE NO.2 ELIMINATE ALL WORK ASSOCIATED WITH <u>25LF</u> ARCHITECTURAL CAST STONE CRACK REPAIR FOR THE 1930'S BUILDING.
- 3. DEDUCT ALTERNATE NO.3 ELIMINATE ALL WORK ASSOCIATED TO REPAIR STAIR AT 1930'S BUILDING.
- 3. DEDUCT ALTERNATE NO.5 ELIMINATE ALL WORK ASSOCIATED TO REPAIR STAIR AT 1950 S BOIL
- 4. DEDUCT ALTERNATE NO.4 ELIMINATE ALL WORK ASSOCIATED WITH 50LF OF SANDSTONE CRACK REPAIR FOR THE 1890'S BUILDING.
- 5. DEDUCT ALTERNATE NO.5 ELIMINATE ALL WORK ASSOCIATED TO POWER WASH AND TO POINT EXTERIOR GRANITE STONE STAIRS AND TO RESEAL CONCRETE LANDING AT MAIN ENTRANCE OF THE 1890'S LIBRARY BUILDING.
- 6. DEDUCT ALTERNATE NO. 6 ELIMINATE ALL WORK ASSOCIATED WITH REPLACING TWO (2) ARCHITECTURAL CAST STONE WINDOW HEADS.

REPAIR & RESTORATION WORK NOTE

LOCALIZED WORK

LIMIT OF WORK

SLATE SHINGLES, TYPICAL

BRICK MASONRY, TYPICAL

METAL PANEL, TYPICAL

WINDOW GLAZING, TYPICAL

1890'S SANDSTONE MASONRY, TYPICAL

1930'S ARCHITECTURAL CAST STONE
MASONRY, TYPICAL

LIMESTONE PANEL TYPE I, TYPICAL

LIMESTONE PANEL TYPE II, TYPICAL

EXTERIOR ELEVATION LEGEND

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EXTERIOR ENVELOPE REPAIRS -BID NO. 18-16



Drawing Title:

NORTH EXTERIOR ELEVATIONS


Revisions:

bmission:

BID DOCUMENTS

Project Number: 17152
Project Manager: ALS
Drawn By: LY/BDO
Scale: 1/8"=1'-0"

A2-04

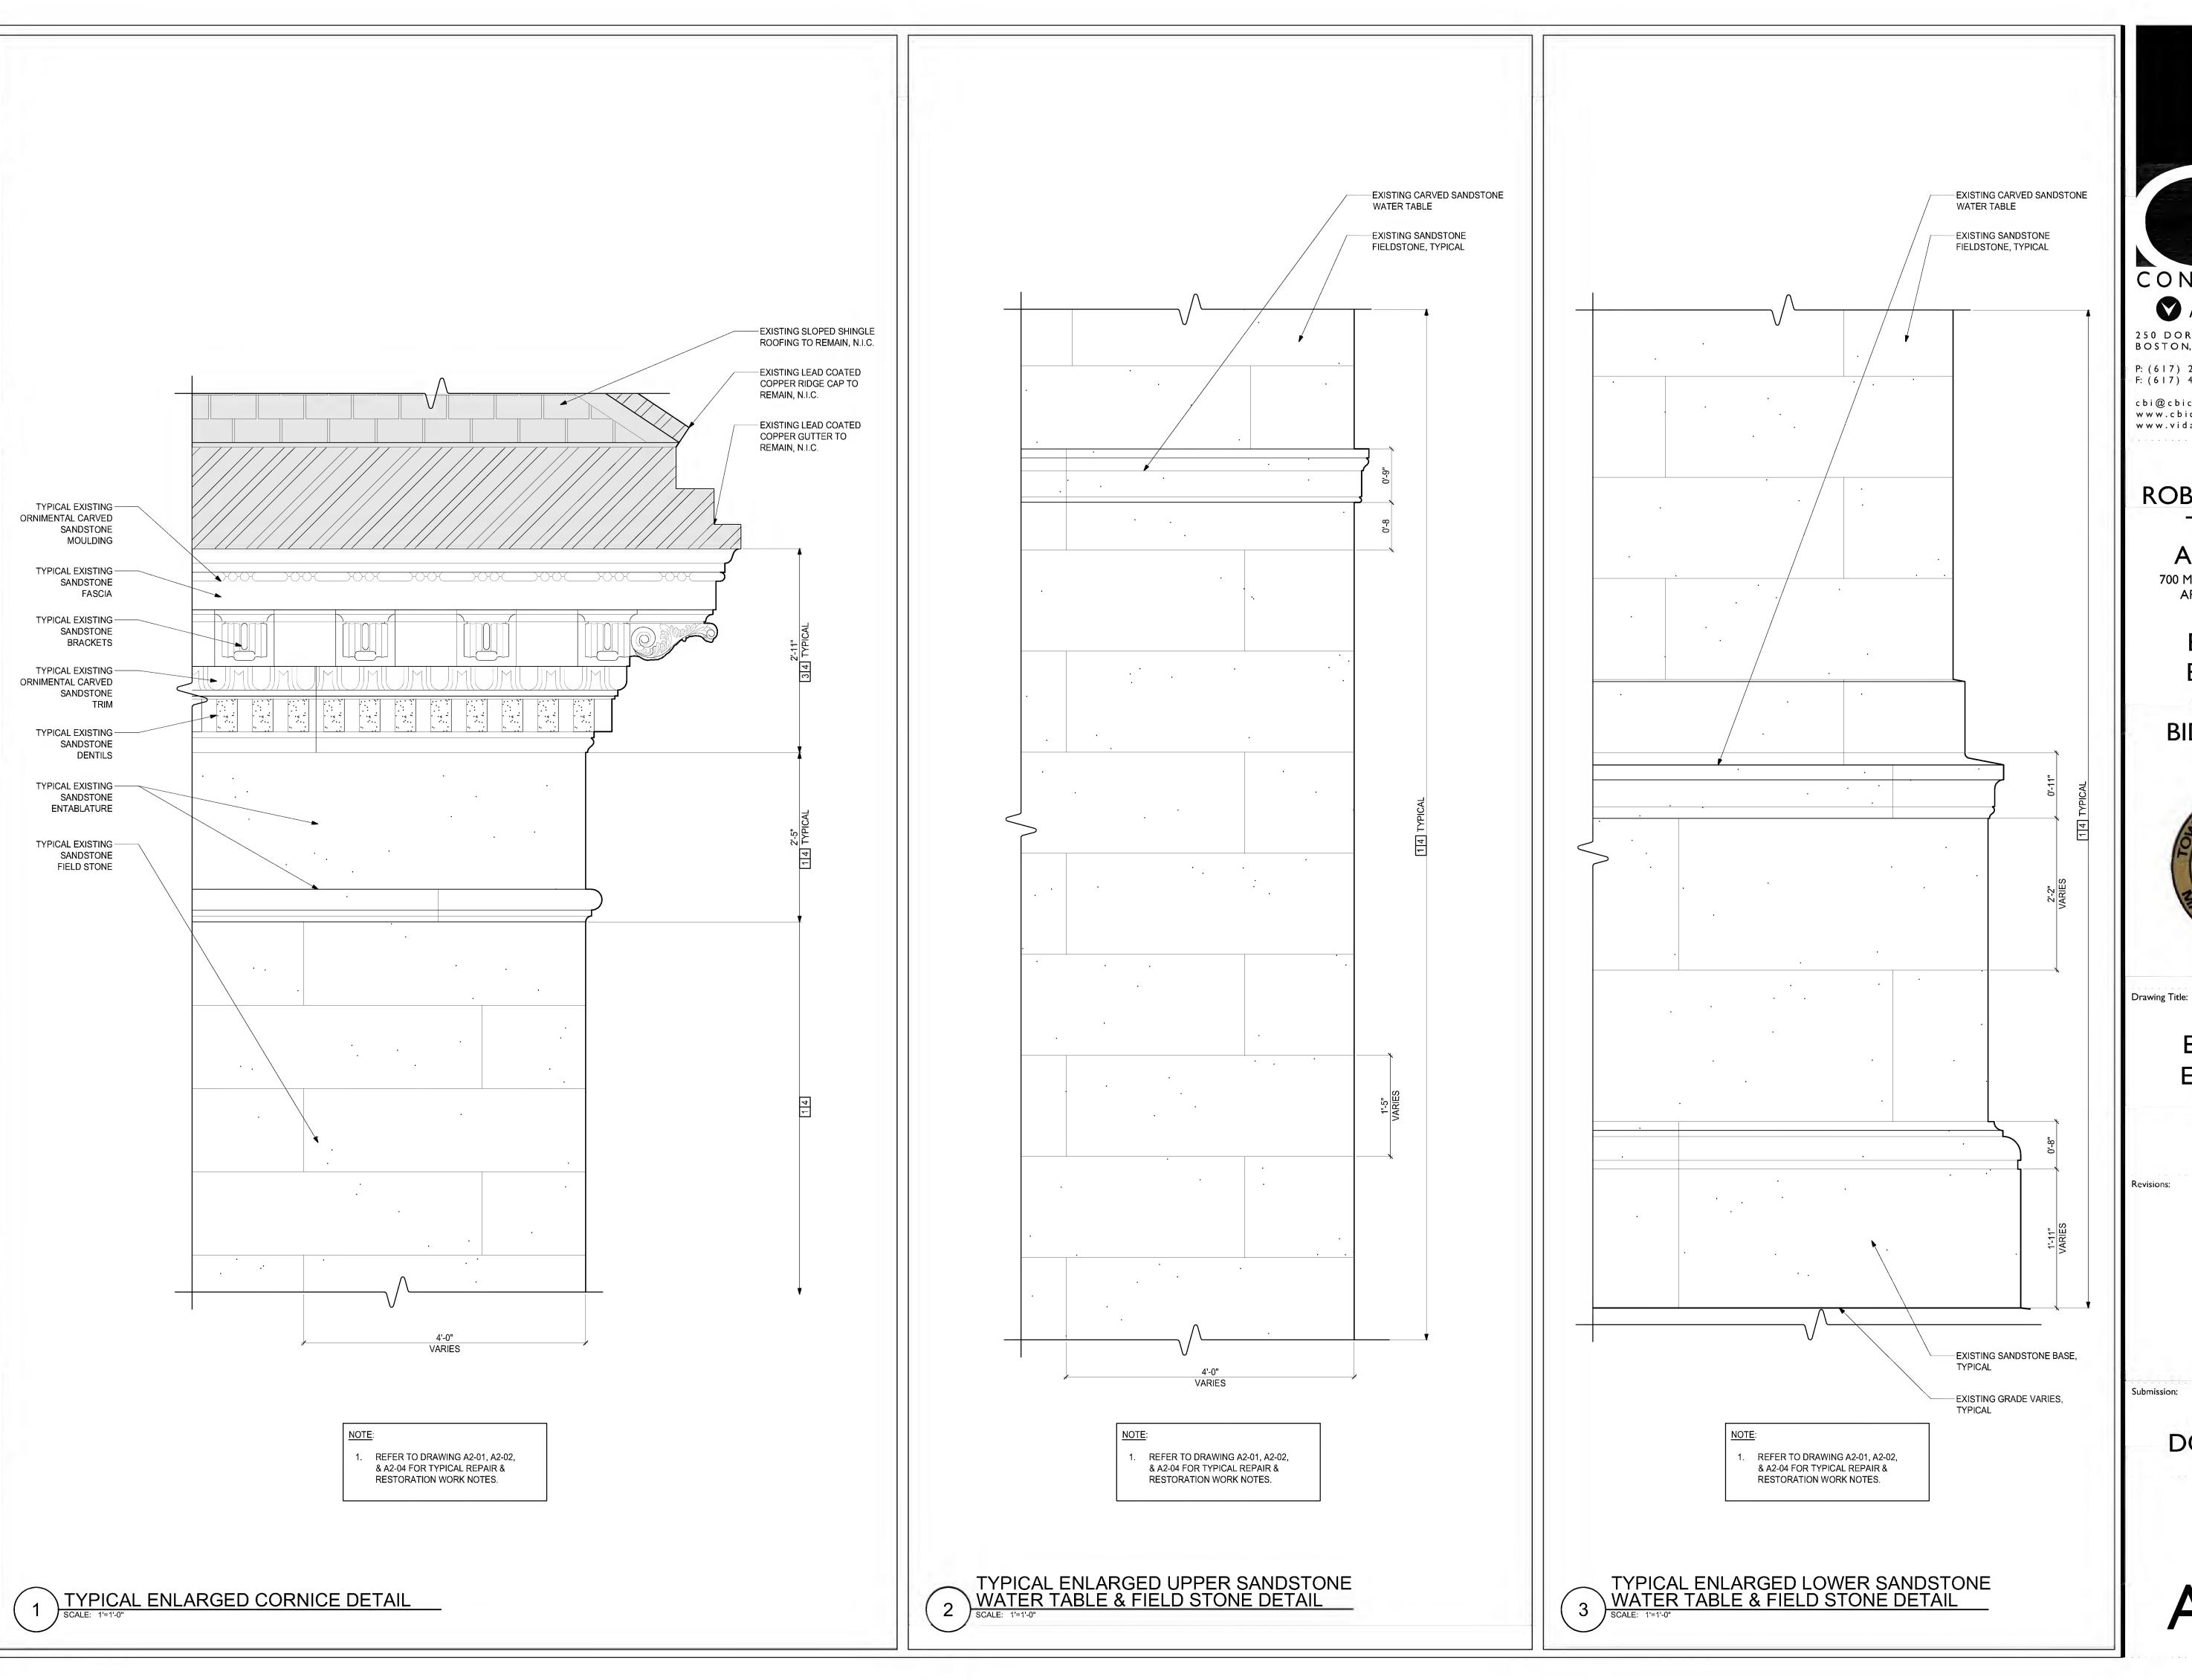



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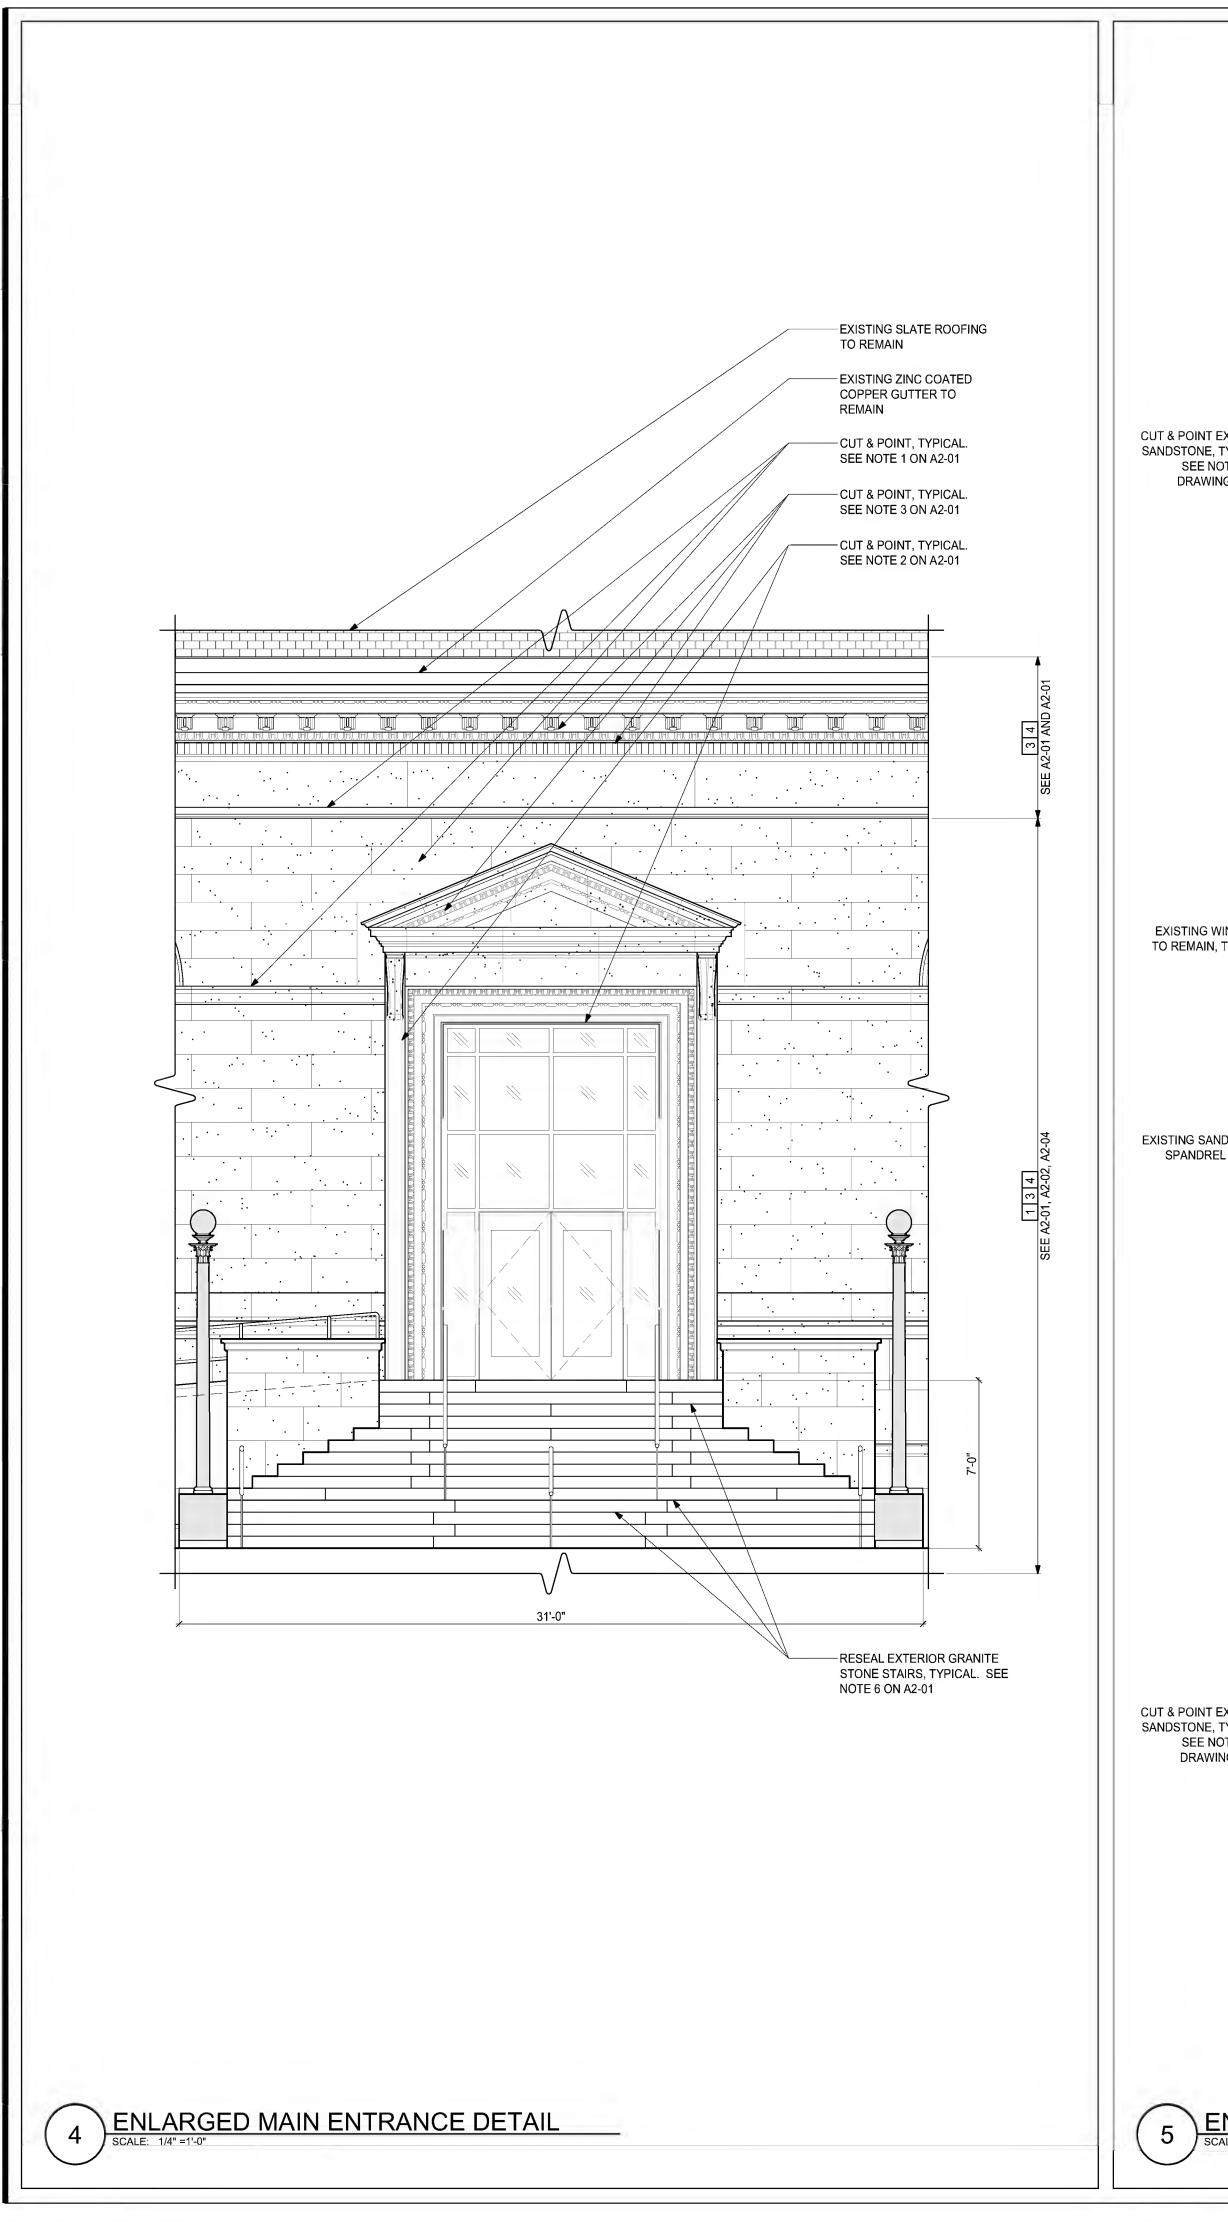
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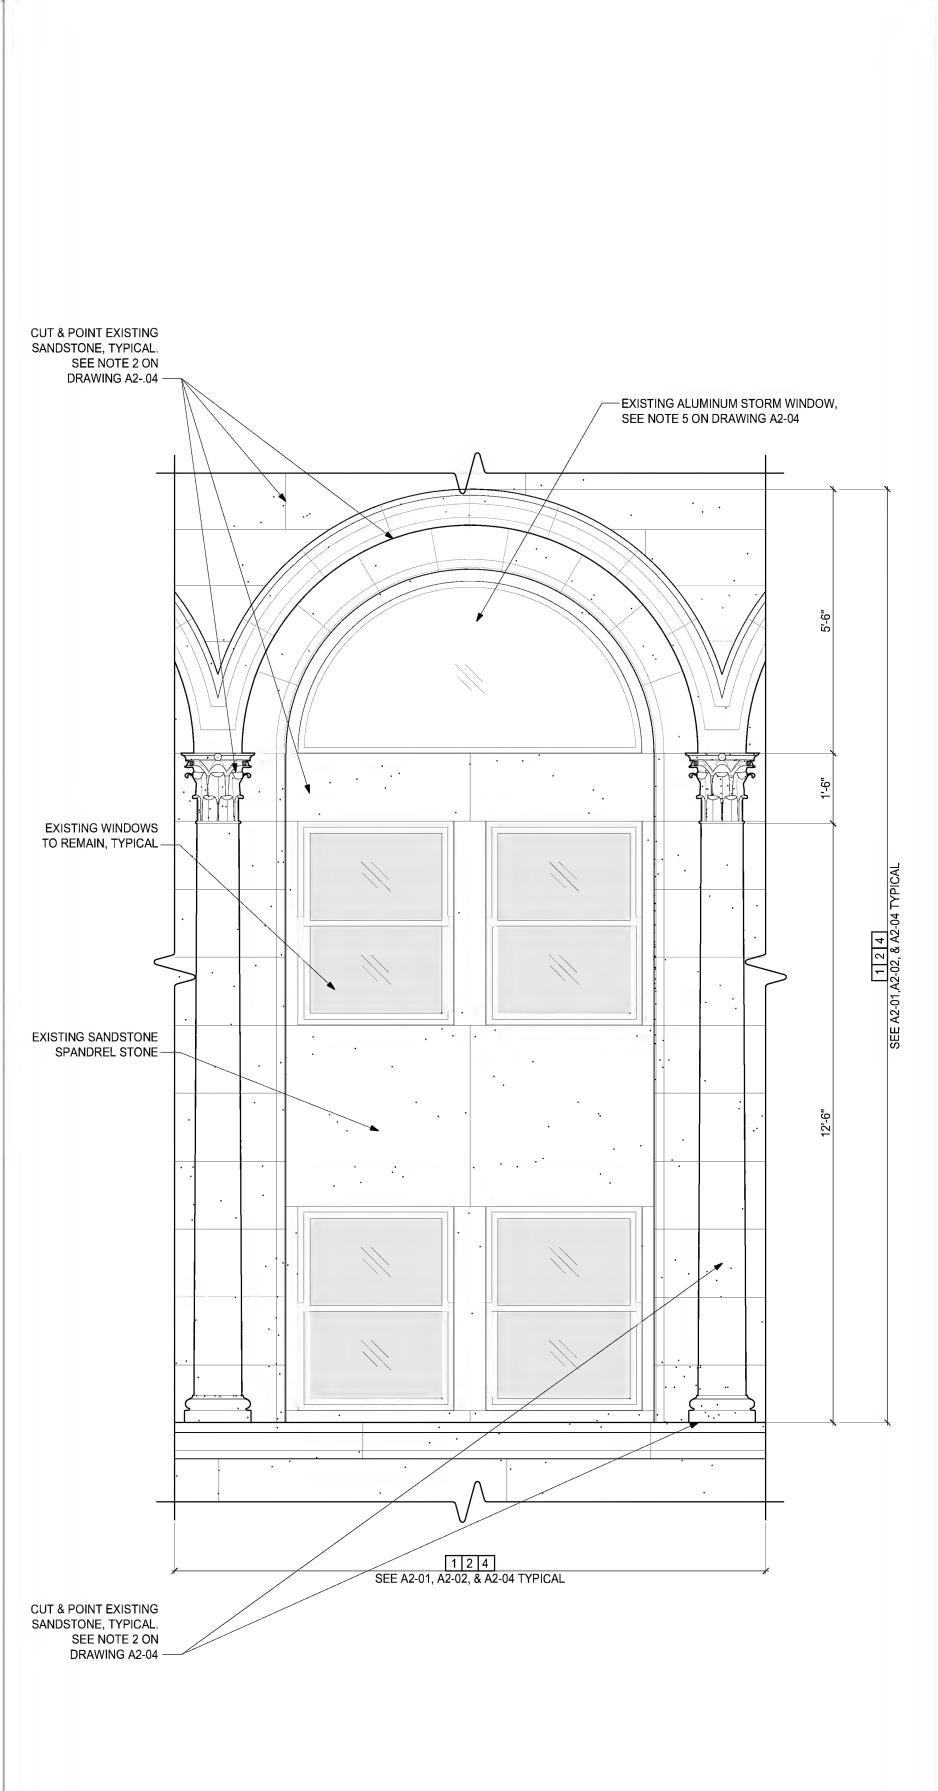
EXTERIOR ENVELOPE REPAIRS -BID NO. 18-16




ENLARGED ELEVATION DETAILS

BID **DOCUMENTS**





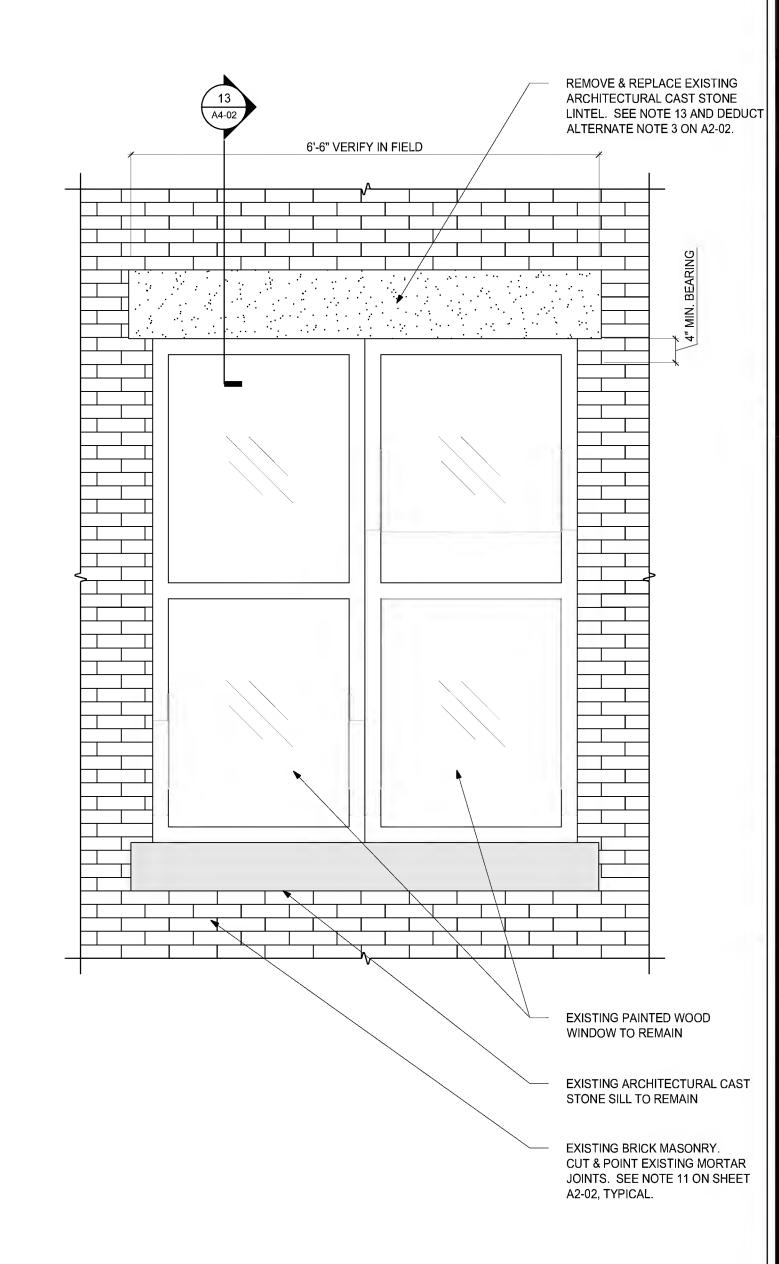

6 ARCHITECTURAL CAST STONE LINTEL ENLARGED ELEVATION



A Vidaris Company

250 DORCHESTER AVENUE
BOSTON, MA 02127

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EXTERIOR ENVELOPE REPAIRS -BID NO. 18-16



Drawing Title:

ENLARGED ELEVATIONS DETAILS

Revisions

Submission:


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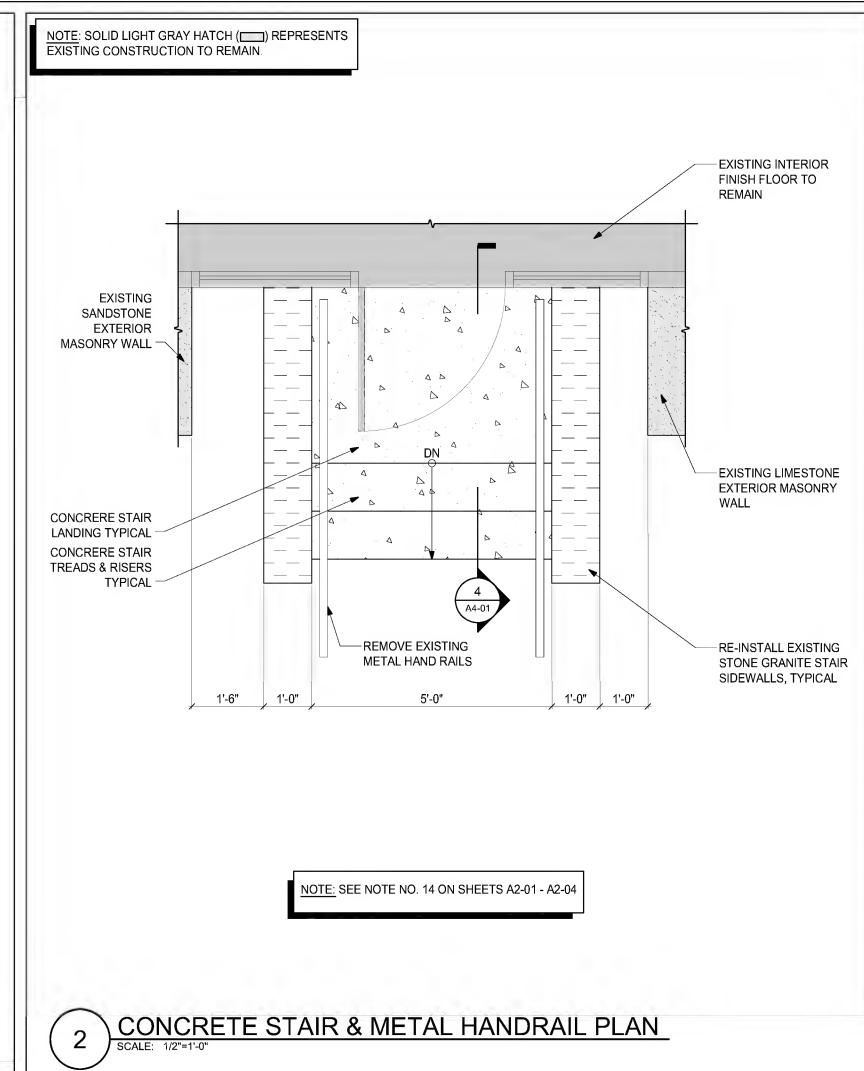
Project Number: 17
Project Manager:
Drawn By: LY/B
Scale: AS SHO


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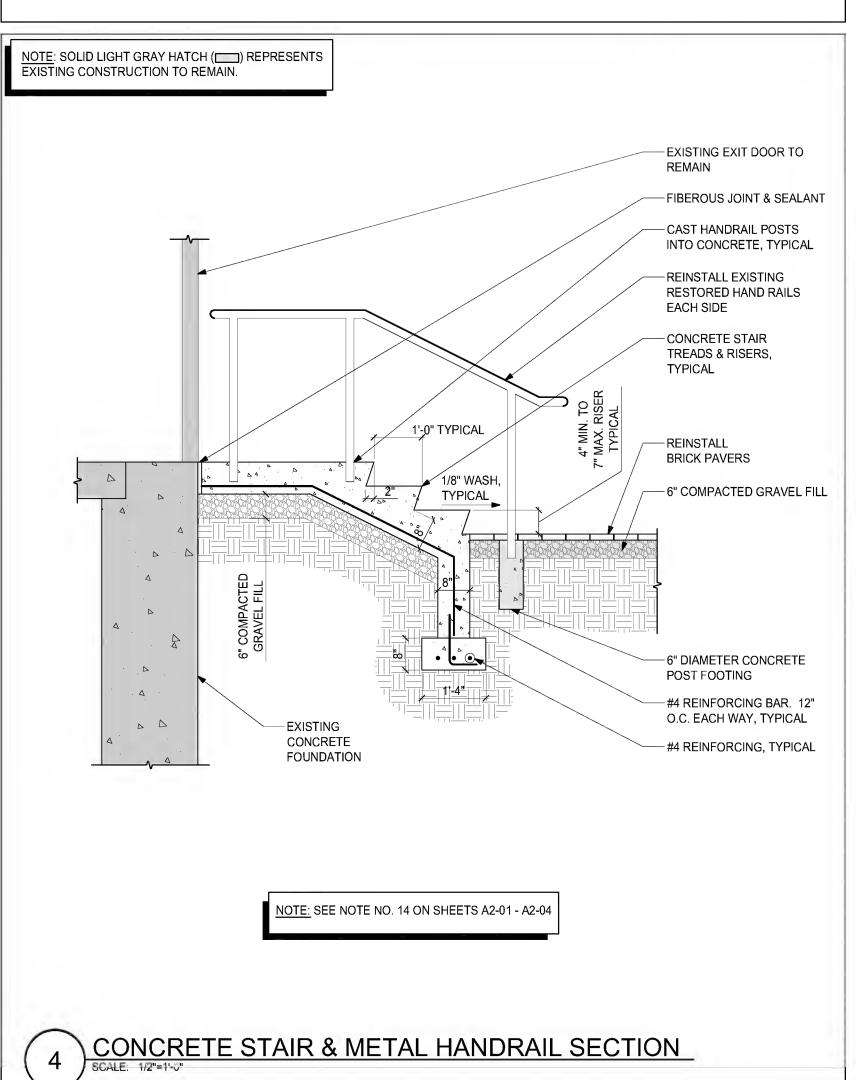
5 ENLARGED WINDOW DETAIL


SCALE: 1/2"=1'-0"





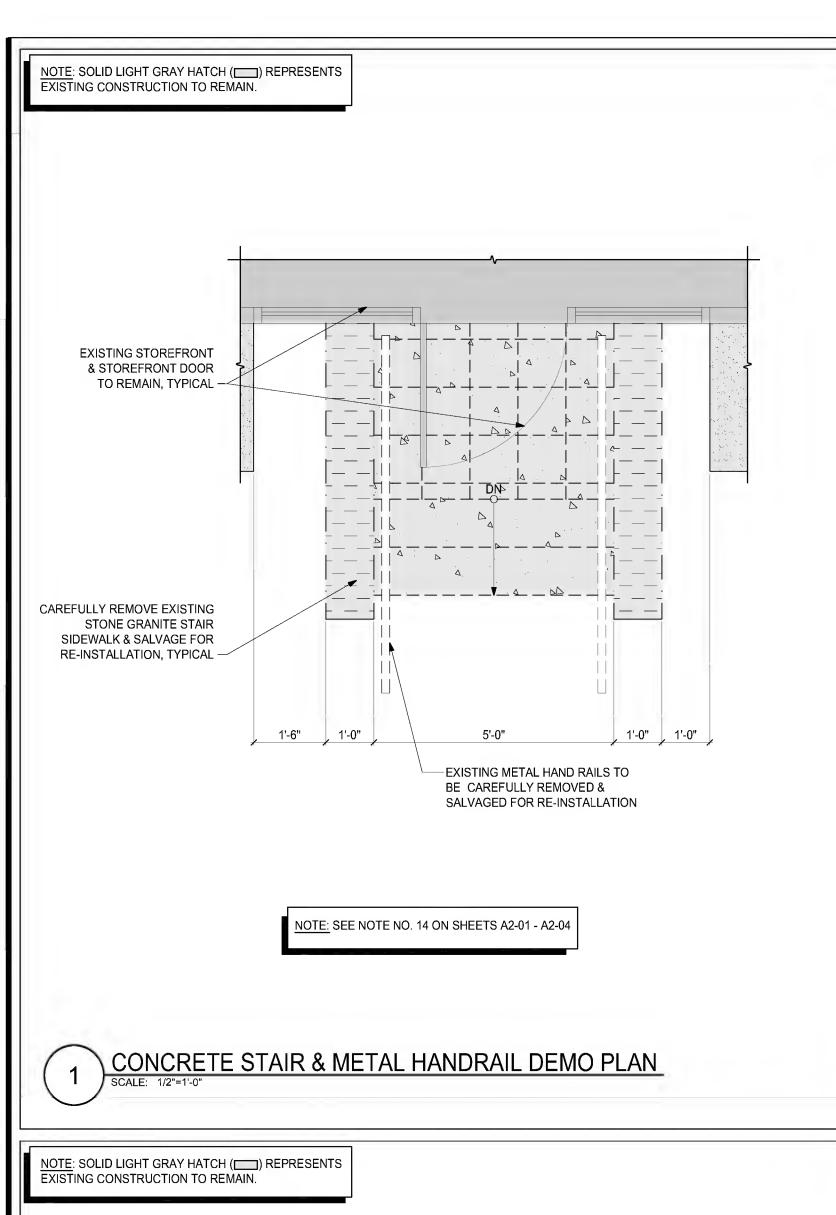

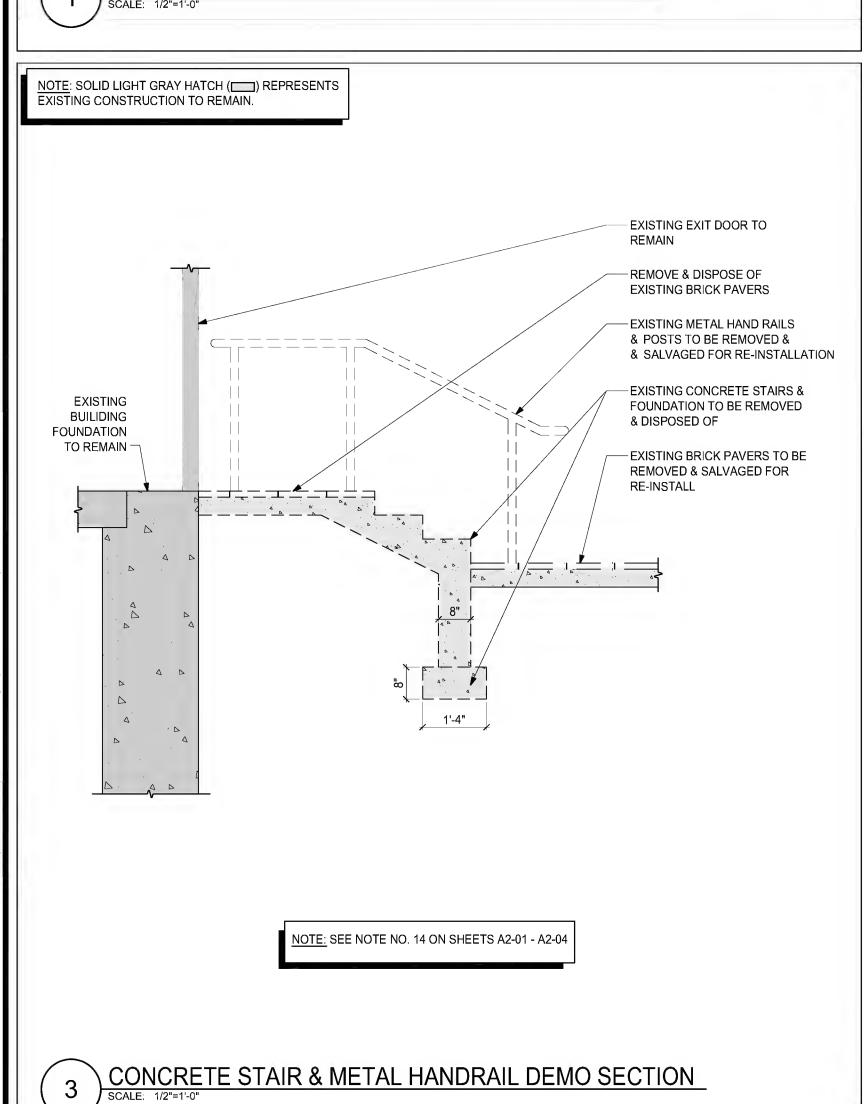

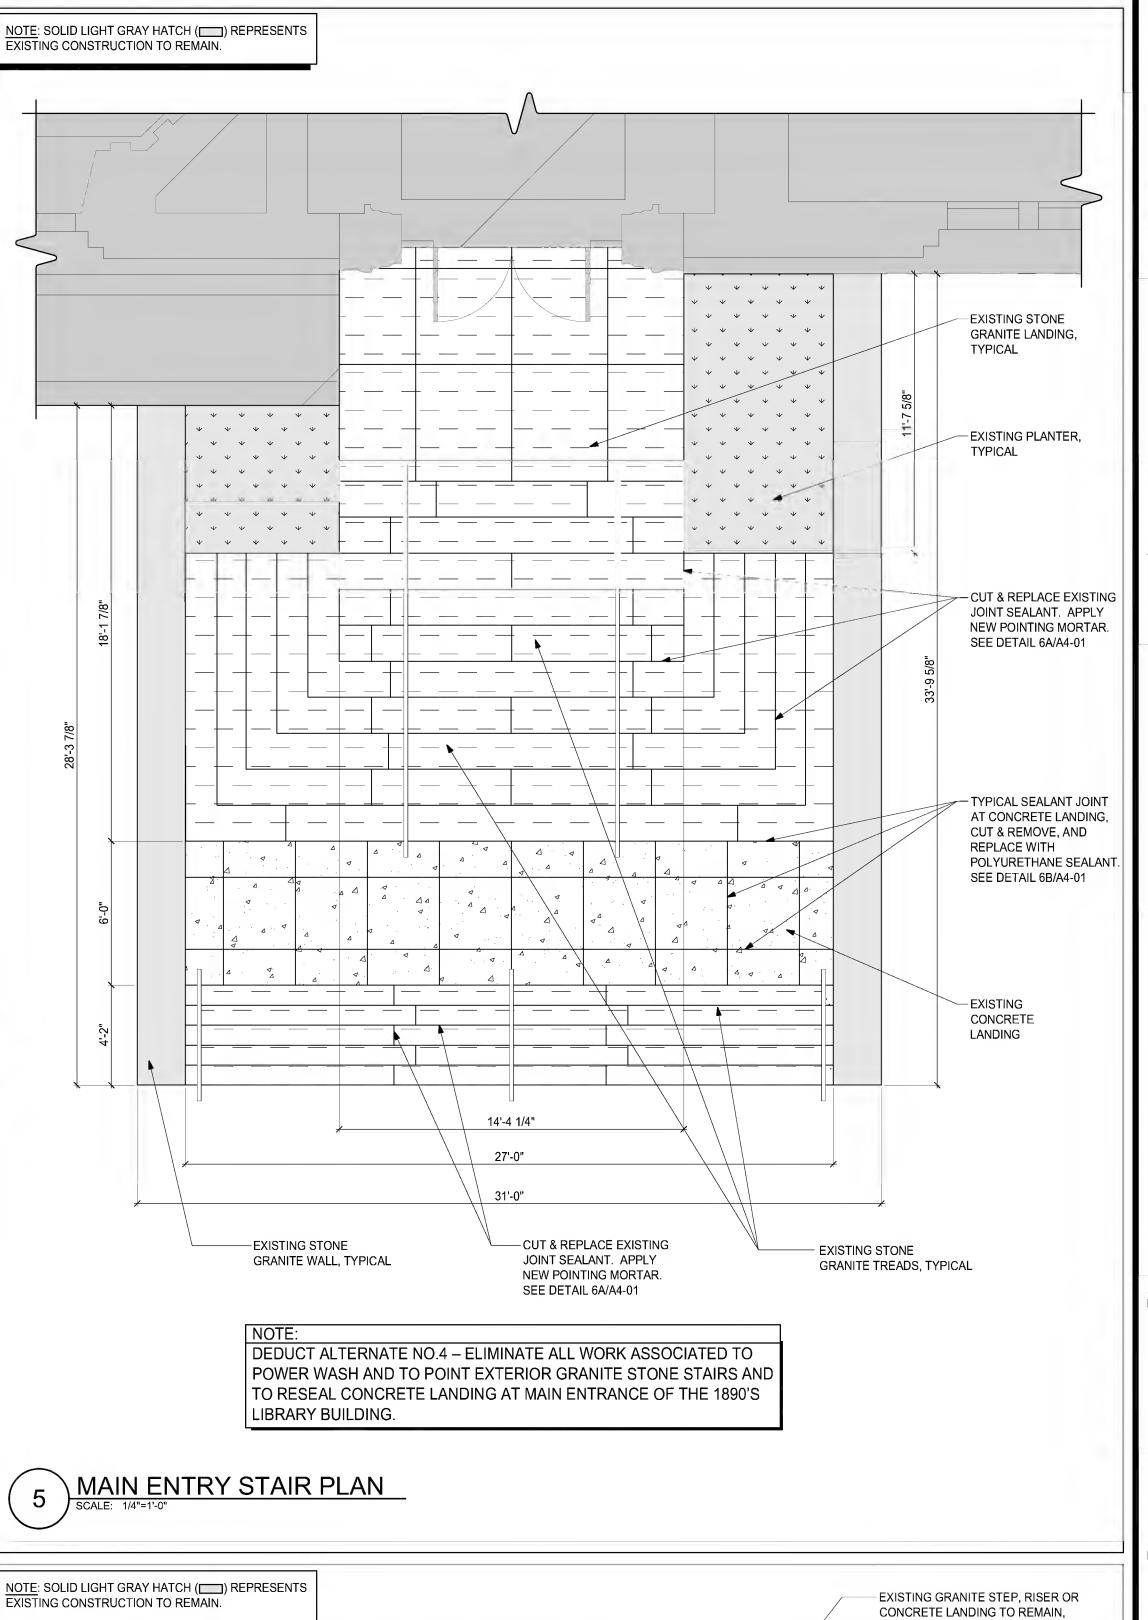

-EXISTING GRANITE STAIR STEP, RISER OR CONCRETE LANDING TO REMAIN, TYPICAL

- CUT, REMOVE, & DISPOSE OF EXISTING SEALANT

- CUT, REMOVE, & DISPOSE OF EXISTING MORTAR

MORTAR TO REMAIN

TYPICAL POINTING OF GRANITE

STONE STAIR JOINT DETAIL

CONSULTING, LLC

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ARLINGTON

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ARLINGTON MA, 02476

EXTERIOR
ENVELOPE
REPAIRS -

BID NO. 18-16



Drawing Title

STAIR REPAIR & RESTORATION DETAILS

Davisions

URETHANE SEALANT

BOND BREAKER TAPE

-EXISTING SOUND MORTAR TO REMAIN

—FILL WITH MORTAR

TYPICAL CONCRETE LANDING

SEALANT JOINT DETAIL

SCALE: 3"=1"-0"

BID DOCUMENTS

Date: 7/5/2018
Project Number: 17152
Project Manager: ALS
Drawn By: BDO
Scale: AS NOTED

A4-01

